


A detailed topographic map of the Worcester, Massachusetts area. The map features contour lines indicating elevation, with major peaks like Barretts Hill and Stratten Hill. Key roads shown include Long Road, Worcester Middlesex Road, and various local streets. Landmarks such as West Pond, Goshen, and the Golf Course are labeled. A red dot marks the 'PROJECT LOCATION' near the intersection of Old Stow Road and the area around St. Michaels Cemetery. Other features include a sewage disposal site, a playground, and several schools.

SHEET INDEX

SHEET NUMBER	SHEET TITLE	REVISION DATE
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SHEET 2	LEGEND, NOTES AND SPECIFICATIONS	12/6/16
SHEET 3	EXISTING CONDITIONS	12/6/16
SHEET 4	LOT LAYOUT PLAN	12/6/16
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SHEET 7	EROSION CONTROL PLAN	12/6/16
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SHEET 9	DETAIL SHEET	12/6/16
SHEET 10	DETAIL SHEET	12/6/16
SHEET 11	ROAD IMPROVEMENT	12/6/16

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 11/12/17
 PROFESSIONAL ENGINEER

I CERTIFY THIS PLAN CONFORMS
TO THE RULES AND REGULATIONS
OF THE REGISTERS OF DEEDS OF THE
COMMONWEALTH OF MASSACHUSETTS

APPROVAL REQUIRED UNDER THE SUBDIVISION CONTROL LAW
DATE APPROVED: _____

_____)
 _____) BEING A MAJORITY
 _____) OF THE STOW
 _____) PLANNING BOARD

DATE ENDORSED: _____

APPROVED SUBJECT TO CONDITIONS SET FORTH
IN A COVENANT EXECUTED BY _____
DATED _____ AND TO BE RECORDED HEREWITH

NO BUILDING OR STRUCTURE SHALL BE BUILT OR PLACED ON ANY LOT WITHOUT A PERMIT FROM THE BOARD OF HEALTH

I, _____, CLERK OF THE TOWN OF
HEREBY CERTIFY THAT THE NOTICE OF THE APPROVAL OF THIS PLAN BY THE
PLANNING BOARD HAS BEEN RECEIVED AND RECORDED BY THIS OFFICE AND
NO APPEAL WAS RECEIVED DURING THE TWENTY (20) DAYS NEXT AFTER
RECEIPT AND RECORDING OF SAID NOTICE.

STOW TOWN CLERK _____ DATE _____

ZONING CLASSIFICATION: RESIDENTIAL (RES)

<u>HAMMERHEAD LOTS:</u>	
FRONTAGE	= 50'
LOT AREA	= 180,000 SQ. FT.
OPEN SPACE (MIN.)	= 10%
FLOOR AREA RATIO	= NR

SETBACKS: FRONT	= 50'
SIDE	= 45'
REAR	= 40'
LOT SHAPE (MIN.)	= 0.25

CONVENTIONAL LOTS:

FRONTAGE	= 200'	SETBACKS: FRONT	= 30'
LOT AREA	= 65,340 SQ. FT.	SIDE	= 25'
OPEN SPACE (MIN.)	= 10%	REAR	= 40'
FLOOR AREA RATIO	= NR	LOT SHAPE (MIN.)	= 0.40

OWNER: RICHARD F. RIEL
113 WALCOTT STREET
STOW, MA 01775

APPLICANT: ROBERT VISCO
30 OLD STOW ROAD
HUDSON, MA 01749

BOOK/PAGE:
BOOK 13501, PAGE 418

MAP/PARCEL:
MAP R-1, PARCEL 31

JILLIAN'S LANE
DEFINITIVE SUBDIVISION DEVELOPMENT
STOW, MASSACHUSETTS
TITLE SHEET

NO.	DATE	DESCRIPTION	BY
2	7/7/16	REVISED PER PLANNING BOARD COMMENTS	PJW
3	8/24/16	REVISED PER PLANNING BOARD DECISION	PJW
4	9/27/16	REVISED DRIVEWAY LOCATION	PJW
5	12/6/16	REVISED PER PLANNING BOARD COMMENTS	PJW
6	1/12/17	REVISED PER PLANNING BOARD DECISION	PJW

PREPARED BY:



DUCHARME & DILLIS
Civil Design Group, Inc.
CIVIL ENGINEERS • LAND SURVEYORS • WETLAND CONSULTANTS

1092 MAIN STREET, P.O. BOX 428
BOLTON, MASSACHUSETTS 01740

PHONE: (978) 779-6091 FAX: (978) 779-0260
www.DucharmeandDillis.com

DESIGN BY:	DRAWN BY:	CHECKED BY:	SHEET NO. 1 OF 11
GSR	GSR	GSR	
DATE:	JOB NUMBER:	DRAWING NO.	
3/18/16	5139	5139-TITLE	

SOIL TEST DATA

SOIL TEST PERFORMED BY GREEN HILL ENGINEERING AND WITNESSED BY BILL BROOKINGS, R.S. NASHOBA ASSOCIATED BOARDS OF HEALTH

TEST HOLE NO. 915-5 DEPTH OF GROUNDWATER: >78"
DATE OF TEST: 09/11/2015 DEPTH OF ESHGW: 28"
SURFACE ELEV.: 282.5 ELEVATION OF ESHGW: 280.2

DEPTH (IN.)	SOIL HOR.	MATRIX COLOR:	REDOX DEPTH/COLOR/%	FEATURES:	SOIL TEXTURE:
0-6"	A	10YR 3/2	-	10YR 6/8	SL
6-30"	B	10YR 6/6	28"	10YR 6/8	SL
30-78"	C	5Y 6/4	-	10YR 6/8	SL

TEST HOLE NO. 915-6 DEPTH OF GROUNDWATER: >96"
DATE OF TEST: 09/11/2015 DEPTH OF ESHGW: 28"
SURFACE ELEV.: 292.5 ELEVATION OF ESHGW: 290.2

DEPTH (IN.)	SOIL HOR.	MATRIX COLOR:	REDOX DEPTH/COLOR/%	FEATURES:	SOIL TEXTURE:
0-6"	A	10YR 3/2	-	10YR 6/8	SL
6-30"	B	10YR 6/6	28"	10YR 6/8	SL
30-96"	C	5Y 6/4	-	10YR 6/8	SL

TEST HOLE NO. 915-7 DEPTH OF GROUNDWATER: >108"
DATE OF TEST: 09/11/2015 DEPTH OF ESHGW: 28"
SURFACE ELEV.: 296.5 ELEVATION OF ESHGW: 294.2

DEPTH (IN.)	SOIL HOR.	MATRIX COLOR:	REDOX DEPTH/COLOR/%	FEATURES:	SOIL TEXTURE:
0-6"	A	10YR 3/2	-	10YR 6/8	SL
6-30"	B	10YR 6/6	28"	10YR 6/8	SL
30-108"	C	5Y 6/4	-	10YR 6/8	SL

TEST HOLE NO. 915-8 DEPTH OF GROUNDWATER: >108"
DATE OF TEST: 09/11/2015 DEPTH OF ESHGW: 28"
SURFACE ELEV.: 300.0 ELEVATION OF ESHGW: 297.7

DEPTH (IN.)	SOIL HOR.	MATRIX COLOR:	REDOX DEPTH/COLOR/%	FEATURES:	SOIL TEXTURE:
0-8"	A	10YR 3/2	-	10YR 6/8	SL
8-30"	B	10YR 6/6	28"	10YR 6/8	SL
30-108"	C	5Y 6/4	-	10YR 6/8	SL

TEST HOLE NO. 915-9 DEPTH OF GROUNDWATER: >96"
DATE OF TEST: 09/11/2015 DEPTH OF ESHGW: 28"
SURFACE ELEV.: 293.0 ELEVATION OF ESHGW: 290.7

DEPTH (IN.)	SOIL HOR.	MATRIX COLOR:	REDOX DEPTH/COLOR/%	FEATURES:	SOIL TEXTURE:
0-8"	A	10YR 3/2	-	10YR 6/8	SL
8-30"	B	10YR 6/6	28"	10YR 6/8	SL
30-96"	C	5Y 6/4	-	10YR 6/8	SL

SOIL TEST PERFORMED BY DUCHARME & DILLIS CIVIL DESIGN GROUP, INC.

TEST HOLE NO. 516-1 DEPTH OF GROUNDWATER: 29"
DATE OF TEST: 05/09/2016 DEPTH OF ESHGW: 25"
SURFACE ELEV.: 249.5 ELEVATION OF ESHGW: 247.4

DEPTH (IN.)	SOIL HOR.	MATRIX COLOR:	REDOX DEPTH/COLOR/%	FEATURES:	SOIL TEXTURE:
0-12"	A	10YR 3/2	-	10YR 6/8	SL
12-29"	B	10YR 6/6	25"	10YR 6/8	SL
29-33"	C	5Y 6/4	-	10YR 6/8	SL

TEST HOLE NO. 516-2 DEPTH OF GROUNDWATER: >36"
DATE OF TEST: 05/09/2016 DEPTH OF ESHGW: 28"
SURFACE ELEV.: 296.5 ELEVATION OF ESHGW: 294.16

DEPTH (IN.)	SOIL HOR.	MATRIX COLOR:	REDOX DEPTH/COLOR/%	FEATURES:	SOIL TEXTURE:
0-10"	A	10YR 3/2	-	10YR 6/8	SL
10-32"	B	10YR 6/6	28"	10YR 6/8	SL
32-36"	C	5Y 6/4	-	10YR 6/8	SL

TEST HOLE NO. 816-1 DEPTH OF GROUNDWATER: >96"
DATE OF TEST: 08/23/2016 DEPTH OF ESHGW: 32"
SURFACE ELEV.: 277.0 ELEVATION OF ESHGW: 274.33

DEPTH (IN.)	SOIL HOR.	MATRIX COLOR:	REDOX DEPTH/COLOR/%	FEATURES:	SOIL TEXTURE:
0-12"	A	10YR 3/3	-	10YR 5/6	SL
12-18"	B	10YR 5/6	-	10YR 5/6	SL
18-96"	C	10YR 5/4	-	10YR 5/4	SL

TEST HOLE NO. 816-2 DEPTH OF GROUNDWATER: >98"
DATE OF TEST: 08/23/2016 DEPTH OF ESHGW: 30"
SURFACE ELEV.: 276.0 ELEVATION OF ESHGW: 275.50

DEPTH (IN.)	SOIL HOR.	MATRIX COLOR:	REDOX DEPTH/COLOR/%	FEATURES:	SOIL TEXTURE:
0-12"	A	10YR 3/3	-	10YR 5/6	SL
12-18"	B	10YR 5/6	-	10YR 5/6	SL
18-98"	C	10YR 5/4	-	10YR 5/4	SL

TEST HOLE NO. 816-3 DEPTH OF GROUNDWATER: >96"
DATE OF TEST: 08/23/2016 DEPTH OF ESHGW: 28"
SURFACE ELEV.: 287 ELEVATION OF ESHGW: 284.67

DEPTH (IN.)	SOIL HOR.	MATRIX COLOR:	REDOX DEPTH/COLOR/%	FEATURES:	SOIL TEXTURE:
0-12"	A	10YR 3/3	-	10YR 5/6	SL
12-24"	B	10YR 5/6	-	10YR 5/6	SL
24-96"	C	10YR 5/4	-	10YR 5/4	SL

TEST HOLE NO. 816-4 DEPTH OF GROUNDWATER: >102"
DATE OF TEST: 08/23/2016 DEPTH OF ESHGW: 28"
SURFACE ELEV.: 289 ELEVATION OF ESHGW: 286.67

DEPTH (IN.)	SOIL HOR.	MATRIX COLOR:	REDOX DEPTH/COLOR/%	FEATURES:	SOIL TEXTURE:
0-10"	A	10YR 3/3	-	10YR 5/6	SL
10-20"	B	10YR 5/6	-	10YR 5/6	SL
20-102"	C	10YR 5/4	-	10YR 5/4	SL

TEST HOLE NO. 816-5 DEPTH OF GROUNDWATER: >84"
DATE OF TEST: 08/23/2016 DEPTH OF ESHGW: 26"
SURFACE ELEV.: 289 ELEVATION OF ESHGW: 286.83

DEPTH (IN.)	SOIL HOR.	MATRIX COLOR:	REDOX DEPTH/COLOR/%	FEATURES:	SOIL TEXTURE:
0-10"	A	10YR 3/3	-	10YR 5/6	SL
10-18"	B	10YR 5/6	-	10YR 5/6	SL
18-84"	C	10YR 5/4	-	10YR 5/4	SL

TEST HOLE NO. 816-6 DEPTH OF GROUNDWATER: >84"
DATE OF TEST: 08/23/2016 DEPTH OF ESHGW: 27"
SURFACE ELEV.: 289 ELEVATION OF ESHGW: 286.75

DEPTH (IN.)	SOIL HOR.	MATRIX COLOR:	REDOX DEPTH/COLOR/%	FEATURES:	SOIL TEXTURE:
0-12"	A	10YR 3/3	-	10YR 5/6	SL
12-24"	B	10YR 5/6	-	10YR 5/6	SL
24-84"	C	10YR 5/4	-	10YR 5/4	SL

LEGEND

EXIST. FEATURE	DESCRIPTION	EXIST. SYM.	DESCRIPTION
---	STREAMS/RIVERS		EXISTING UTILITY POLE
---	LIMIT OF RIVERFRONT AREA		EXISTING GUY WIRE
---	LAKES/PONDS/SURFACE WATER		EX. STORM WATER MANHOLE
---	WETLANDS		EXISTING WELL
---	LIMIT OF BUFFER ZONE		EXISTING WETLAND FLAG
---	WELL RADIUS		EXISTING CATCH BASIN
---	PROPERTY LINE		EXISTING ELECTRICAL METER
---	EASEMENT LINE		EXISTING SIGN
---	SLOPES >15%		PERC TEST
---	HAYBALES		TEST PIT
---	GUARD RAIL		EXISTING IRON PIPE
---	STONE WALL		EXISTING DRILL HOLE
---	EXISTING ELECTRICAL LINE		EXISTING IRON ROD
---	EXISTING SANITARY SEWER		EXISTING STONE BOUND
---	EXISTING STORM DRAIN		EXISTING IRON PIPE
---	EXISTING TELEPHONE LINE		EXISTING DRILL HOLE
---	EXISTING OVER-HEAD WIRES		EXISTING IRON ROD
---	EXISTING UNPAVED ROAD		EXISTING STONE BOUND
---	EXISTING CONTOUR (INDEX)		DECIDUOUS TREE
---	EX. CONTOUR (INTERMEDIATE)		CONIFER TREE
---	EXISTING SPOT ELEVATION		SHRUB
---	EXISTING BUILDING/HOUSE		EXISTING CLEANOUT
---	TREE LINE		

PROP. FEATURE	DESCRIPTION	PROP. SYM.	DESCRIPTION
---	REPLICATED WETLANDS		PROPOSED UTILITY POLE
---	PROPERTY LINE		PROPOSED SANITARY MANHOLE
---	EASEMENT LINE		PROPOSED STORM WATER MANHOLE
---	STRAW BALES		PROPOSED CATCH BASIN
---	CONC. BLOCK RETAINING WALL		PROPOSED DOUBLE CATCH BASIN
---	PROPOSED WATER LINE		PROPOSED ELECTRICAL TRANSFORMER
---	PROPOSED SANITARY SEWER		PROPOSED SIGN
---	PROPOSED STORM DRAIN		PROPOSED FLARED END SECTION
---	PROPOSED UNDER DRAIN		PROPOSED RIPRAP
---	PRO. U/G ELEC. CABLE & TEL.		PROPOSED STONE BOUND PER SUBDIVISION REGS
---	BCCB		PROPOSED IRON ROD PER SUBDIVISION REGS
---	EOP		DECIDUOUS TREE
---	PROPOSED UNPAVED ROAD		
---	PROPOSED CONTOUR (INDEX)		
---	PROP. CONTOUR (INTERMEDIATE)		
---	PROPOSED SPOT ELEVATION		
---	PROPOSED BUILDING/HOUSE		
---	TREE LINE		
---	PROP. CONSERVATION BOUND		
---	6"x6"x36" CONC. BOUND		
---	SEE NHPSP GUIDANCE FOR SPECS		

GENERAL NOTES/REFERENCES:

- TOPOGRAPHICAL INFORMATION IS A RESULT ON AN ON-THE-GROUND SURVEY BY DUCHARME & DILLIS CIVIL DESIGN GROUP, INC. ELEVATIONS REFER TO NAVD 88 DATUM.
- PROPERTY LINE INFORMATION WAS PREPARED BY DUCHARME & DILLIS CIVIL DESIGN GROUP, INC. BASED ON AN ON-THE-GROUND SURVEY AND PLANS AND DEEDS OF RECORD.
- ALL SOIL TESTING LOCATIONS ARE BASED ON TESTS PERFORMED BY GREEN HILL ENGINEERING IN 2015 AND DUCHARME & DILLIS CIVIL DESIGN GROUP, INC. IN 2016.
- EXISTING UTILITIES SHOWN ON THIS PLAN WERE COMPILED FROM FIELD MEASUREMENT AND AERIAL PHOTOS. THE UTILITIES SHOWN ON THIS PLAN ARE FOR REFERENCE ONLY AND SHOULD NOT BE ASSUMED TO BE CORRECT NOR SHOULD IT BE ASSUMED THAT THE UTILITIES SHOWN ARE THE ONLY UTILITIES LOCATED ON OR NEAR THE SITE. THE CONTRACTOR SHALL CALL DIG SAFE 1-888-DIG-SAFE PRIOR TO CONSTRUCTION IN ACCORDANCE WITH STATE LAWS.
- PRIOR TO ANY SITE WORK FOR THE DWELLING UNITS, JILLIAN'S LANE OR COMMON DRIVEWAY, THE EXTENDED BASIN AND CULVERT UPGRADE SHALL TAKE PLACE.

GRADING NOTES/SPECIFICATIONS:

A. SITE PREPARATION:

- A STORMWATER POLLUTION PREVENTION PLAN IS REQUIRED FOR THE SITE. THE CONTRACTOR IS RESPONSIBLE TO UPDATING THE STORMWATER POLLUTION PREVENTION PLAN FOR THE APPLICABLE CONTACTS, AND FOR MAKING REGULAR INSPECTIONS DURING CONSTRUCTION. PRIOR TO CONSTRUCTION THE CONTRACTOR SHALL FILE THE REQUIRE EPA NOTICE OF INTENT FOR COVERAGE UNDER THE NPDES PROGRAM; CONTRACTOR TO PLACE EROSION CONTROL BARRIER AS SPECIFIED ON THESE PLANS AND IN ACCORDANCE WITH ALL APPROVALS FROM THE TOWN OF STOW AND IN ACCORDANCE WITH THE STORMWATER POLLUTION PREVENTION PLAN.
- CONSTRUCTION VEHICLES ARE PROHIBITED FROM USING MITCHELL ROAD.
- CONTRACTOR SHALL STAKE ALL LIMITS OF CLEARING PRIOR TO CONSTRUCTION.
- GRADES SHOWN ON THIS PLAN REFER TO FINAL FINISHED GRADES.
- PORTIONS OF THE INFILTRATION POND SLOPES SHALL BE GRADED AT A 2:1 SLOPE WITH EROSION CONTROL MATS AS SHOWN ON THE EROSION CONTROL PLAN.
- ALL SLOPES GRADED AT 3:1 OR GREATER SHALL HAVE EROSION CONTROL MATS AS SHOWN ON THE EROSION CONTROL PLAN.
- ALL SLOPES, UNLESS OTHERWISE NOTED SHALL BE GRADED AT 3:1.
- TEMPORARY SEEDING, MULCHING OR OTHER SUITABLE STABILIZATION METHOD MAY BE USED TO PROTECT EXPOSED SOIL DURING CONSTRUCTION.
- ALL SLOPES SHALL BE COVERED WITH TOPSOIL TO A DEPTH OF AT LEAST 6 INCHES AND PLANTED WITH VEGETATIVE COVER SUFFICIENT TO PREVENT EROSION.
- PERMANENT SEEDING SHOULD BE UNDERTAKEN DURING THE SPRING, SUMMER AND EARLY FALL. PERMANENT VEGETATION SHALL BE INSTALLED AS SOON AS POSSIBLE AFTER CONSTRUCTION IS COMPLETE, AND NO LATER THAN THE FIRST FULL SPRING THEREAFTER.
- NO STRIPPED AREA OR AREAS SHALL REMAIN THROUGH WINTER WITHOUT TEMPORARY COVER OF WINTER RYE OR SIMILAR PLANT MATERIAL BEING PROVIDED FOR SOIL CONTROL.
- REMOVE TREES WITHIN THE LIMIT OF CLEARING AS REQUIRED FOR CONSTRUCTION. TREES WITHIN THE LIMIT OF CLEARING AND OUTSIDE OF THE INFLUENCE OF ROADWAYS, HOUSES, DRIVEWAYS, SEPTIC SYSTEMS, UTILITIES AND ASSOCIATED GRADING SHALL BE SAVED IF POSSIBLE.
- STUMPS SHALL BE REMOVED AND DISPOSED OF IN ACCORDANCE WITH THE TOWN OF STOW SPECIFICATIONS.
- THE INFILTRATION POND SHALL BE CONSTRUCTED AT THE BEGINNING OF THE SITE WORK TO TREAT THE RUN OFF GENERATED AND MAINTAINED THROUGHOUT THE CONSTRUCTION OF THE PROJECT.

B. DRIVEWAYS:

- THE COMMON DRIVEWAY SHALL NOT SERVE, AT ANY TIME, MORE THAN THE TWO LOTS FOR USES ALLOWED IN THE STOW ZONING BYLAW.
- DRIVEWAYS TO BE CONSTRUCTED IN ACCORDANCE WITH THE TOWN OF STOW DRIVEWAY REGULATIONS AND SHARED DRIVEWAY REGULATIONS.
- NO PAVING SHALL TAKE PLACE FROM NOVEMBER 15 TO MARCH 15 OF ANY YEAR WITHOUT PRIOR PLANNING BOARD APPROVAL.
- DRIVEWAYS SHALL BE 12' IN WIDTH WITH 4 FOOT SHOULDERS. (SEE TYPICAL CROSS SECTION)
- THE TRAVELED WAY SHALL CONTAIN A GRAVEL SUBBASE SPREAD IN TWO LAYERS PER MASSACHUSETTS STANDARD SPECIFICATION FOR HIGHWAYS AND BRIDGES (SSH&B) SECTION 401.60. THE BOTTOM 12 INCHES SHALL CONFORM TO SSH&B M.1.03.0 TYPE A. THE TOP 4 INCHES SHALL CONFORM TO SSH&B M.2.01.7. THE TRAVEL WAY SHALL BE SUPERELEVATED AT A 1/4" INCH PER FOOT WITH A BINDER COARSE OF 2 INCHES COMPACTED MEASURE. A TOP COARSE SHALL BE COMPACTED TO 1-1/2 INCHES. COMPACTION SHALL BE PERFORMED WITH A VIBRATORY ROLLER.
- DRIVEWAYS TO HAVE A MINIMUM SLOPE OF 0.75% AND A MAXIMUM SLOPE OF 10%.
- DRIVEWAY EMBANKMENTS TO BE NO STEEPER THAN 2:1. SWALE ALONG DRIVEWAY AND COMMON DRIVEWAY SHALL BE NO STEEPER THAN 1.5:1.
- DRIVEWAYS TO BE CONSTRUCTED IN THE LOCATIONS SHOWN. MODIFICATIONS TO DRIVEWAYS SHALL BE APPROVED BY THE ENGINEER PRIOR TO CONSTRUCTION.
- SHOULDERS SHALL BE CONSTRUCTED OF RECYCLED ASPHALT PAVEMENT (RAP) AND SHALL CONFORM TO SPECIFICATIONS AS STATED IN SECTION M.11.0 OF MASS HIGHWAY STANDARD SPECIFICATIONS FOR HIGHWAYS AND BRIDGES.

C. DRAINAGE:

- STORMWATER MANAGEMENT AREAS TO BE CONSTRUCTED IN THE LOCATION SHOWN ON THE PLANS.
- PROVIDE UNDERGROUND ROOFTOP INFILTRATION SYSTEM AS SHOWN. REFER TO THE DETAIL SHEET FOR CONSTRUCTION DETAILS.
- STONE RIPRAP SHALL BE 4" TO 12" ANGULAR RIPRAP PLACED OVER FILTER FABRIC.
- ALL SWALES AND CHECK DAMS TO BE RESTORED WITH 4" TO 12" RIPRAP, 1' IN DEPTH.

UTILITY NOTES/SPECIFICATIONS:

A. DRAINAGE STRUCTURES:

- CATCH BASIN FRAME & GRATE TO BE AS MANUFACTURED AS SHOWN ON PLANS.
- CONTRACTOR TO SET DRAIN MANHOLE COVERS TO FINAL FINISHED GRADE AS SHOWN ON THE GRADING PLAN.
- UNDERGROUND INFILTRATION CHAMBERS SHALL BE ADS STORMTECH RC-310 PRODUCT, OR APPROVED EQUAL. SEE DETAILS SHEETS. PROVIDE CUT SHEETS TO ENGINEER FOR APPROVAL.
- MANHOLE GRATES SHALL BE MAINTAINED DURING AND AFTER CONSTRUCTION TO ENSURE UNOBSTRUCTED DRAINAGE. SEE THE OPERATION AND MAINTENANCE MANUAL FOR TYPICAL CLEANING ACTIVITIES AND SCHEDULE.

B. ELECTRICAL/TELEPHONE/CABLE:

- UTILITY CONNECTIONS TO THE PROPOSED LOTS SHALL BE UNDERGROUND SERVICE CONNECTIONS IN COMPLIANCE WITH THE APPLICABLE UTILITY COMPANIES SPECIFICATIONS.
- CONTRACTOR TO COORDINATE WITH APPROPRIATE UTILITY COMPANIES FOR THE CONSTRUCTION OF THE CONDUIT FOR UNDERGROUND UTILITIES.
- CONTRACTOR TO FACILITATE THE RELOCATION OF THE EXISTING UTILITY POLE(S) AS SHOWN ON THE PLAN FOR CONNECTION OF UNDERGROUND UTILITIES FOR THE PROJECT AS IS DETERMINED TO BE REQUIRED BY THE UTILITY COMPANY.
- CONTRACTOR SHALL COMPLY WITH ALL LOCAL, STATE AND FEDERAL REGULATIONS AND REQUIREMENTS FOR THE INSTALLATION OF UTILITIES.
- CONTRACTOR TO COMPLY WITH ALL SPECIFICATIONS AND REQUIREMENTS OF THE INDIVIDUAL UTILITY COMPANY.
- NO EXTERIOR LIGHT FIXTURES SHALL SHINE ON ADJACENT PROPERTIES OR TOWARDS ANY STREET IN SUCH A MANNER AS TO CREATE A NUISANCE OR HAZARD. ALL EXTERIOR LIGHTING SHALL COMPLY WITH SECTION 3.8.1.5 OF THE STOW BYLAWS. ALL FIXTURES WITH A RATE OUTPUT OF 2,000 LUMENS OR MORE MUST BE FULL-CUTOFF FIXTURES.

C. PIPE:

- ALL DRAINAGE PIPE TO BE HDPE AS MANUFACTURED BY ADVANCED DRAINAGE SYSTEM, INC., OR APPROVED EQUAL.
- ALL CONDUIT FOR UTILITIES TO BE AS SPECIFIED BY THE APPROPRIATE UTILITY COMPANY.
- BACKFILL SHALL BE AS SHOWN ON THE PIPE IN TRENCH DETAIL ON SHEET 8 OF 9.

 PROFESSIONAL ENGINEER	RESERVED FOR REGISTRY USE
 PROFESSIONAL LAND SURVEYOR	
I CERTIFY THIS PLAN CONFORMS TO THE RULES AND REGULATIONS OF THE REGISTERS OF DEEDS OF THE COMMONWEALTH OF MASSACHUSETTS	


APPROVAL REQUIRED UNDER THE SUBDIVISION CONTROL LAW	
DATE APPROVED: _____	
_____	BEING A MAJORITY OF THE STOW PLANNING BOARD

DATE ENDORSED: _____	
APPROVED SUBJECT TO CONDITIONS SET FORTH IN A COVENANT EXECUTED BY _____ DATED _____ AND TO BE RECORDED HEREWITH	
NO BUILDING OR STRUCTURE SHALL BE BUILT OR PLACED ON ANY LOT WITHOUT A PERMIT FROM THE BOARD OF HEALTH	
I, _____ CLERK OF THE TOWN OF _____ HEREBY CERTIFY THAT THE NOTICE OF THE APPROVAL OF THIS PLAN BY THE PLANNING BOARD HAS BEEN RECEIVED AND RECORDED BY THIS OFFICE AND NO APPEAL WAS RECEIVED DURING THE TWENTY (20) DAYS NEXT AFTER RECEIPT AND RECORDING OF SAID NOTICE.	
STOW TOWN CLERK	DATE




ZONING CLASSIFICATION: RESIDENTIAL (RES)	
HAMMERHEAD LOTS:	
FRONTAGE = 50'	SETBACKS: FRONT = 50'
LOT AREA = 180,000 SQ. FT.	SIDE = 45'
OPEN SPACE (MIN.) = 10%	REAR = 40'
FLOOR AREA RATIO = NR	LOT SHAPE (MIN.) = 0.25
CONVENTIONAL LOTS:	
FRONTAGE = 200'	SETBACKS: FRONT = 30'
LOT AREA = 65,340 SQ. FT.	SIDE = 25'
OPEN SPACE (MIN.) = 10%	REAR = 40'
FLOOR AREA RATIO = NR	LOT SHAPE (MIN.) = 0.40



OWNER: RICHARD F. RIEL 113 WALCOTT STREET STOW, MA 01775	APPLICANT: ROBERT VESCO 30 OLD STOW ROAD HUDSON, MA 01749
BOOK/PAGE: BOOK 13501, PAGE 418	MAP/PARCEL: MAP R-1, PARCEL 31

JILLIAN'S LANE DEFINIIVE SUBDIVISION DEVELOPMENT STOW, MASSACHUSETTS LEGEND, NOTES AND SPECIFICATIONS			
NO.	DATE	DESCRIPTION	BY
2	7/7/16	REVISED PER PLANNING BOARD COMMENTS	PJW
3	8/24/16	REVISED PER PLANNING BOARD DECISION	PJW
4	9/27/16	REVISED DRIVEWAY LOCATION	PJW
5	12/6/16	REVISED PER PLANNING BOARD COMMENTS	PJW
6	1/12/17	REVISED PER PLANNING BOARD DECISION	PJW

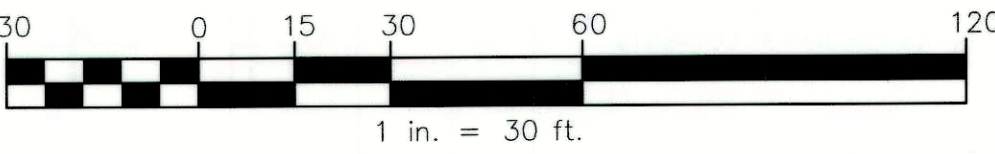


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 PROFESSIONAL ENGINEER	RESERVED FOR REGISTRY USE		
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I CERTIFY THIS PLAN CONFORMS TO THE RULES AND REGULATIONS OF THE REGISTERS OF DEEDS OF THE COMMONWEALTH OF MASSACHUSETTS			
APPROVAL REQUIRED UNDER THE SUBDIVISION CONTROL LAW DATE APPROVED: _____ _____) _____) _____) _____) _____) _____) _____) _____) BEING A MAJORITY OF THE STOW PLANNING BOARD DATE ENDORSED: _____			
APPROVED SUBJECT TO CONDITIONS SET FORTH IN A COVENANT EXECUTED BY _____ AND TO BE RECORDED HEREWITH DATED _____ NO BUILDING OR STRUCTURE SHALL BE BUILT OR PLACED ON ANY LOT WITHOUT A PERMIT FROM THE BOARD OF HEALTH I, _____, CLERK OF THE TOWN OF _____, HEREBY CERTIFY THAT THE NOTICE OF THE APPROVAL OF THIS PLAN BY THE PLANNING BOARD HAS BEEN RECEIVED AND RECORDED BY THIS OFFICE AND NO APPEAL WAS RECEIVED DURING THE TWENTY (20) DAYS NEXT AFTER RECEIPT AND RECORDING OF SAID NOTICE. STOW TOWN CLERK _____ DATE _____			
ZONING CLASSIFICATION: RESIDENTIAL (RES) STOW HAMMERHEAD LOTS: FRONTAGE = 50' SETBACKS: FRONT = 50' LOT AREA = 180,000 SQ. FT. SIDE = 45' OPEN SPACE (MIN.) = 10% REAR = 40' FLOOR AREA RATIO = NR LOT SHAPE (MIN.) = 0.25 CONVENTIONAL LOTS: FRONTAGE = 200' SETBACKS: FRONT = 30' LOT AREA = 65,340 SQ. FT. SIDE = 25' OPEN SPACE (MIN.) = 10% REAR = 40' FLOOR AREA RATIO = NR LOT SHAPE (MIN.) = 0.40			
OWNER: RICHARD F. RIEL 113 WALCOTT STREET STOW, MA 01775	APPLICANT: ROBERT VISCO 30 OLD STOW ROAD HUDSON, MA 01749		
BOOK/PAGE: BOOK 13501, PAGE 418	MAP/PARCEL: MAP R-1, PARCEL 31		
JILLIAN'S LANE DEFINITIVE SUBDIVISION DEVELOPMENT STOW, MASSACHUSETTS EXISTING CONDITIONS			
NO.	DATE	DESCRIPTION	BY
2	7/7/16	REVISED PER PLANNING BOARD COMMENTS	P/JW
3	8/24/16	REVISED PER PLANNING BOARD DECISION	P/JW
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5	12/6/16	REVISED PER PLANNING BOARD COMMENTS	P/JW
6	1/12/17	REVISED PER PLANNING BOARD DECISION	P/JW
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DESIGN BY: GSR	DRAWN BY: GSR	CHECKED BY: GSR	SHEET NO. 3
DATE: 3/18/16	JOB NUMBER: 5139	DRAWING NO. 5139-EXIST	

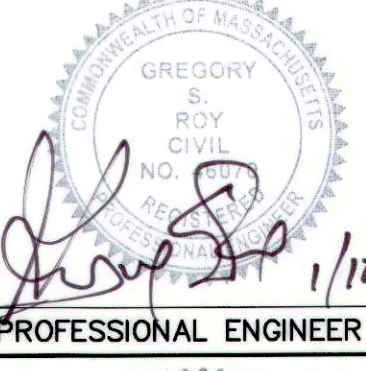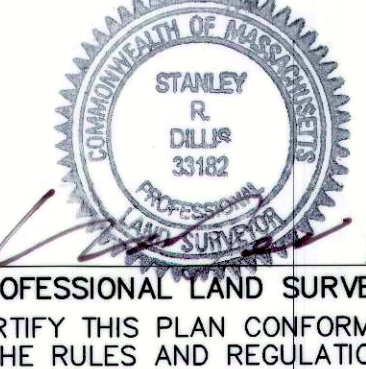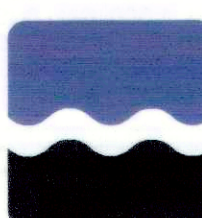

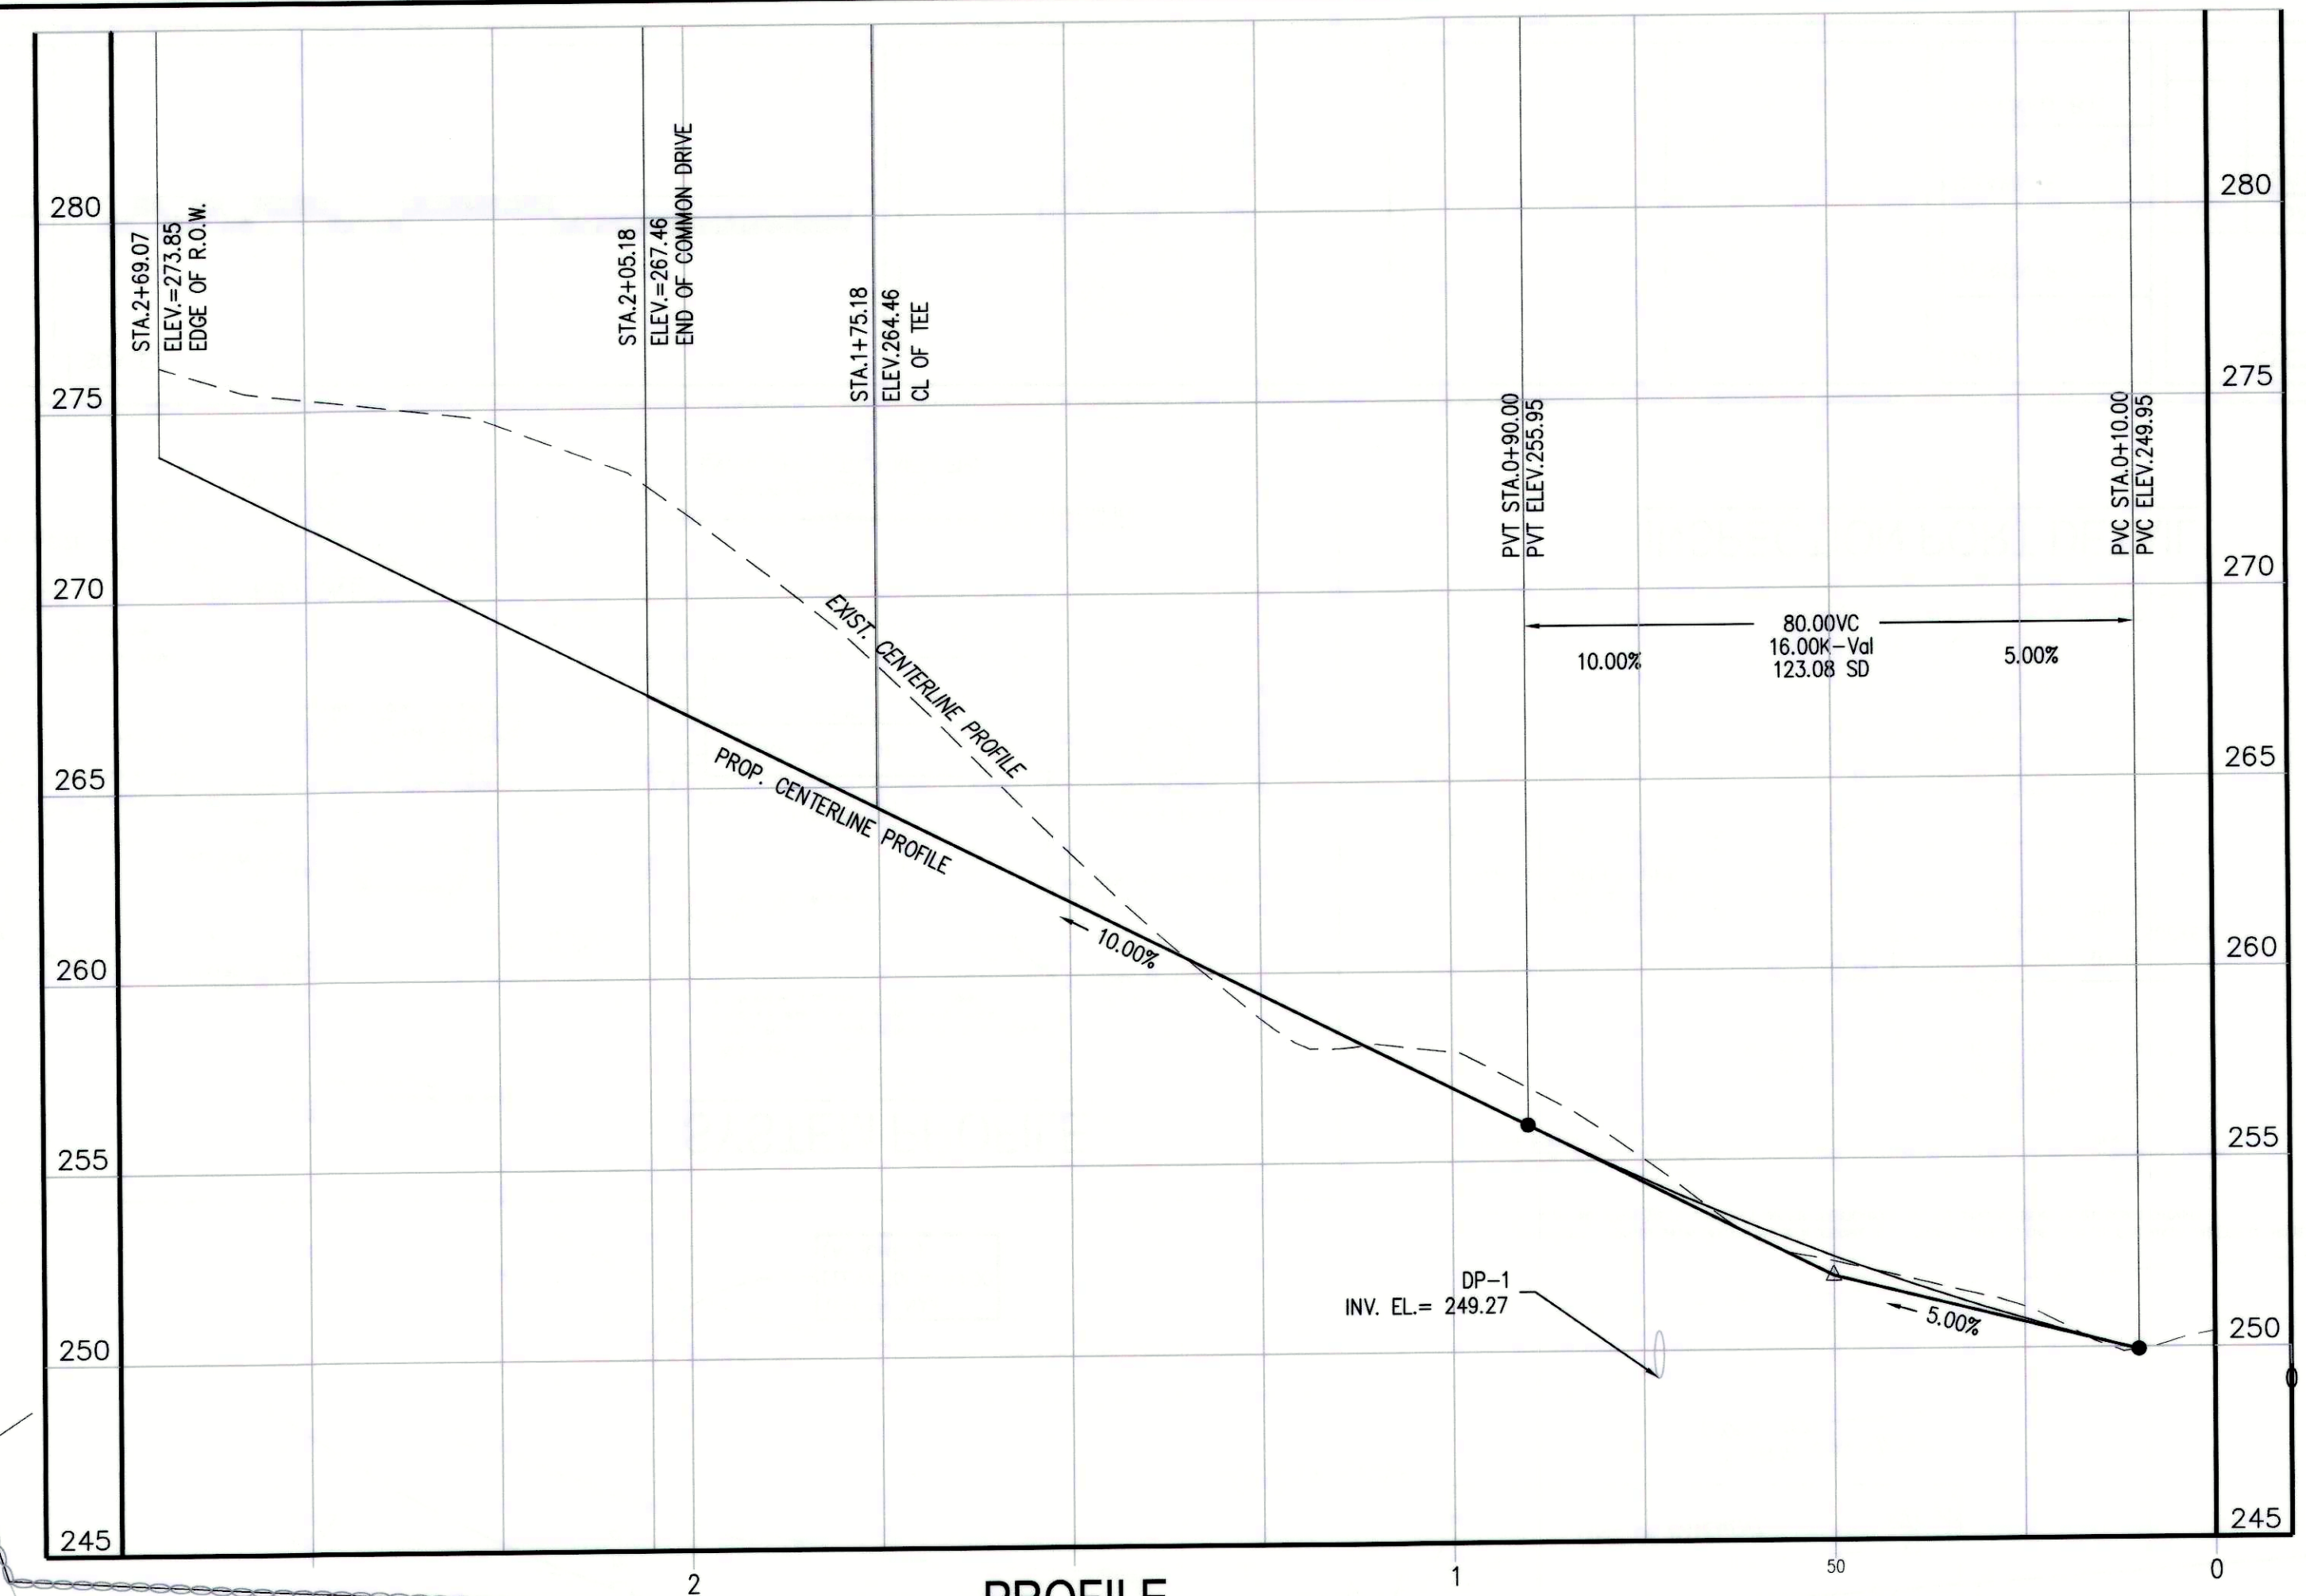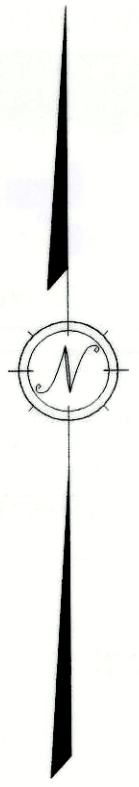
PROFILE

SCALE: 1" = 20' (HOR.)
1" = 4' (VERT.)

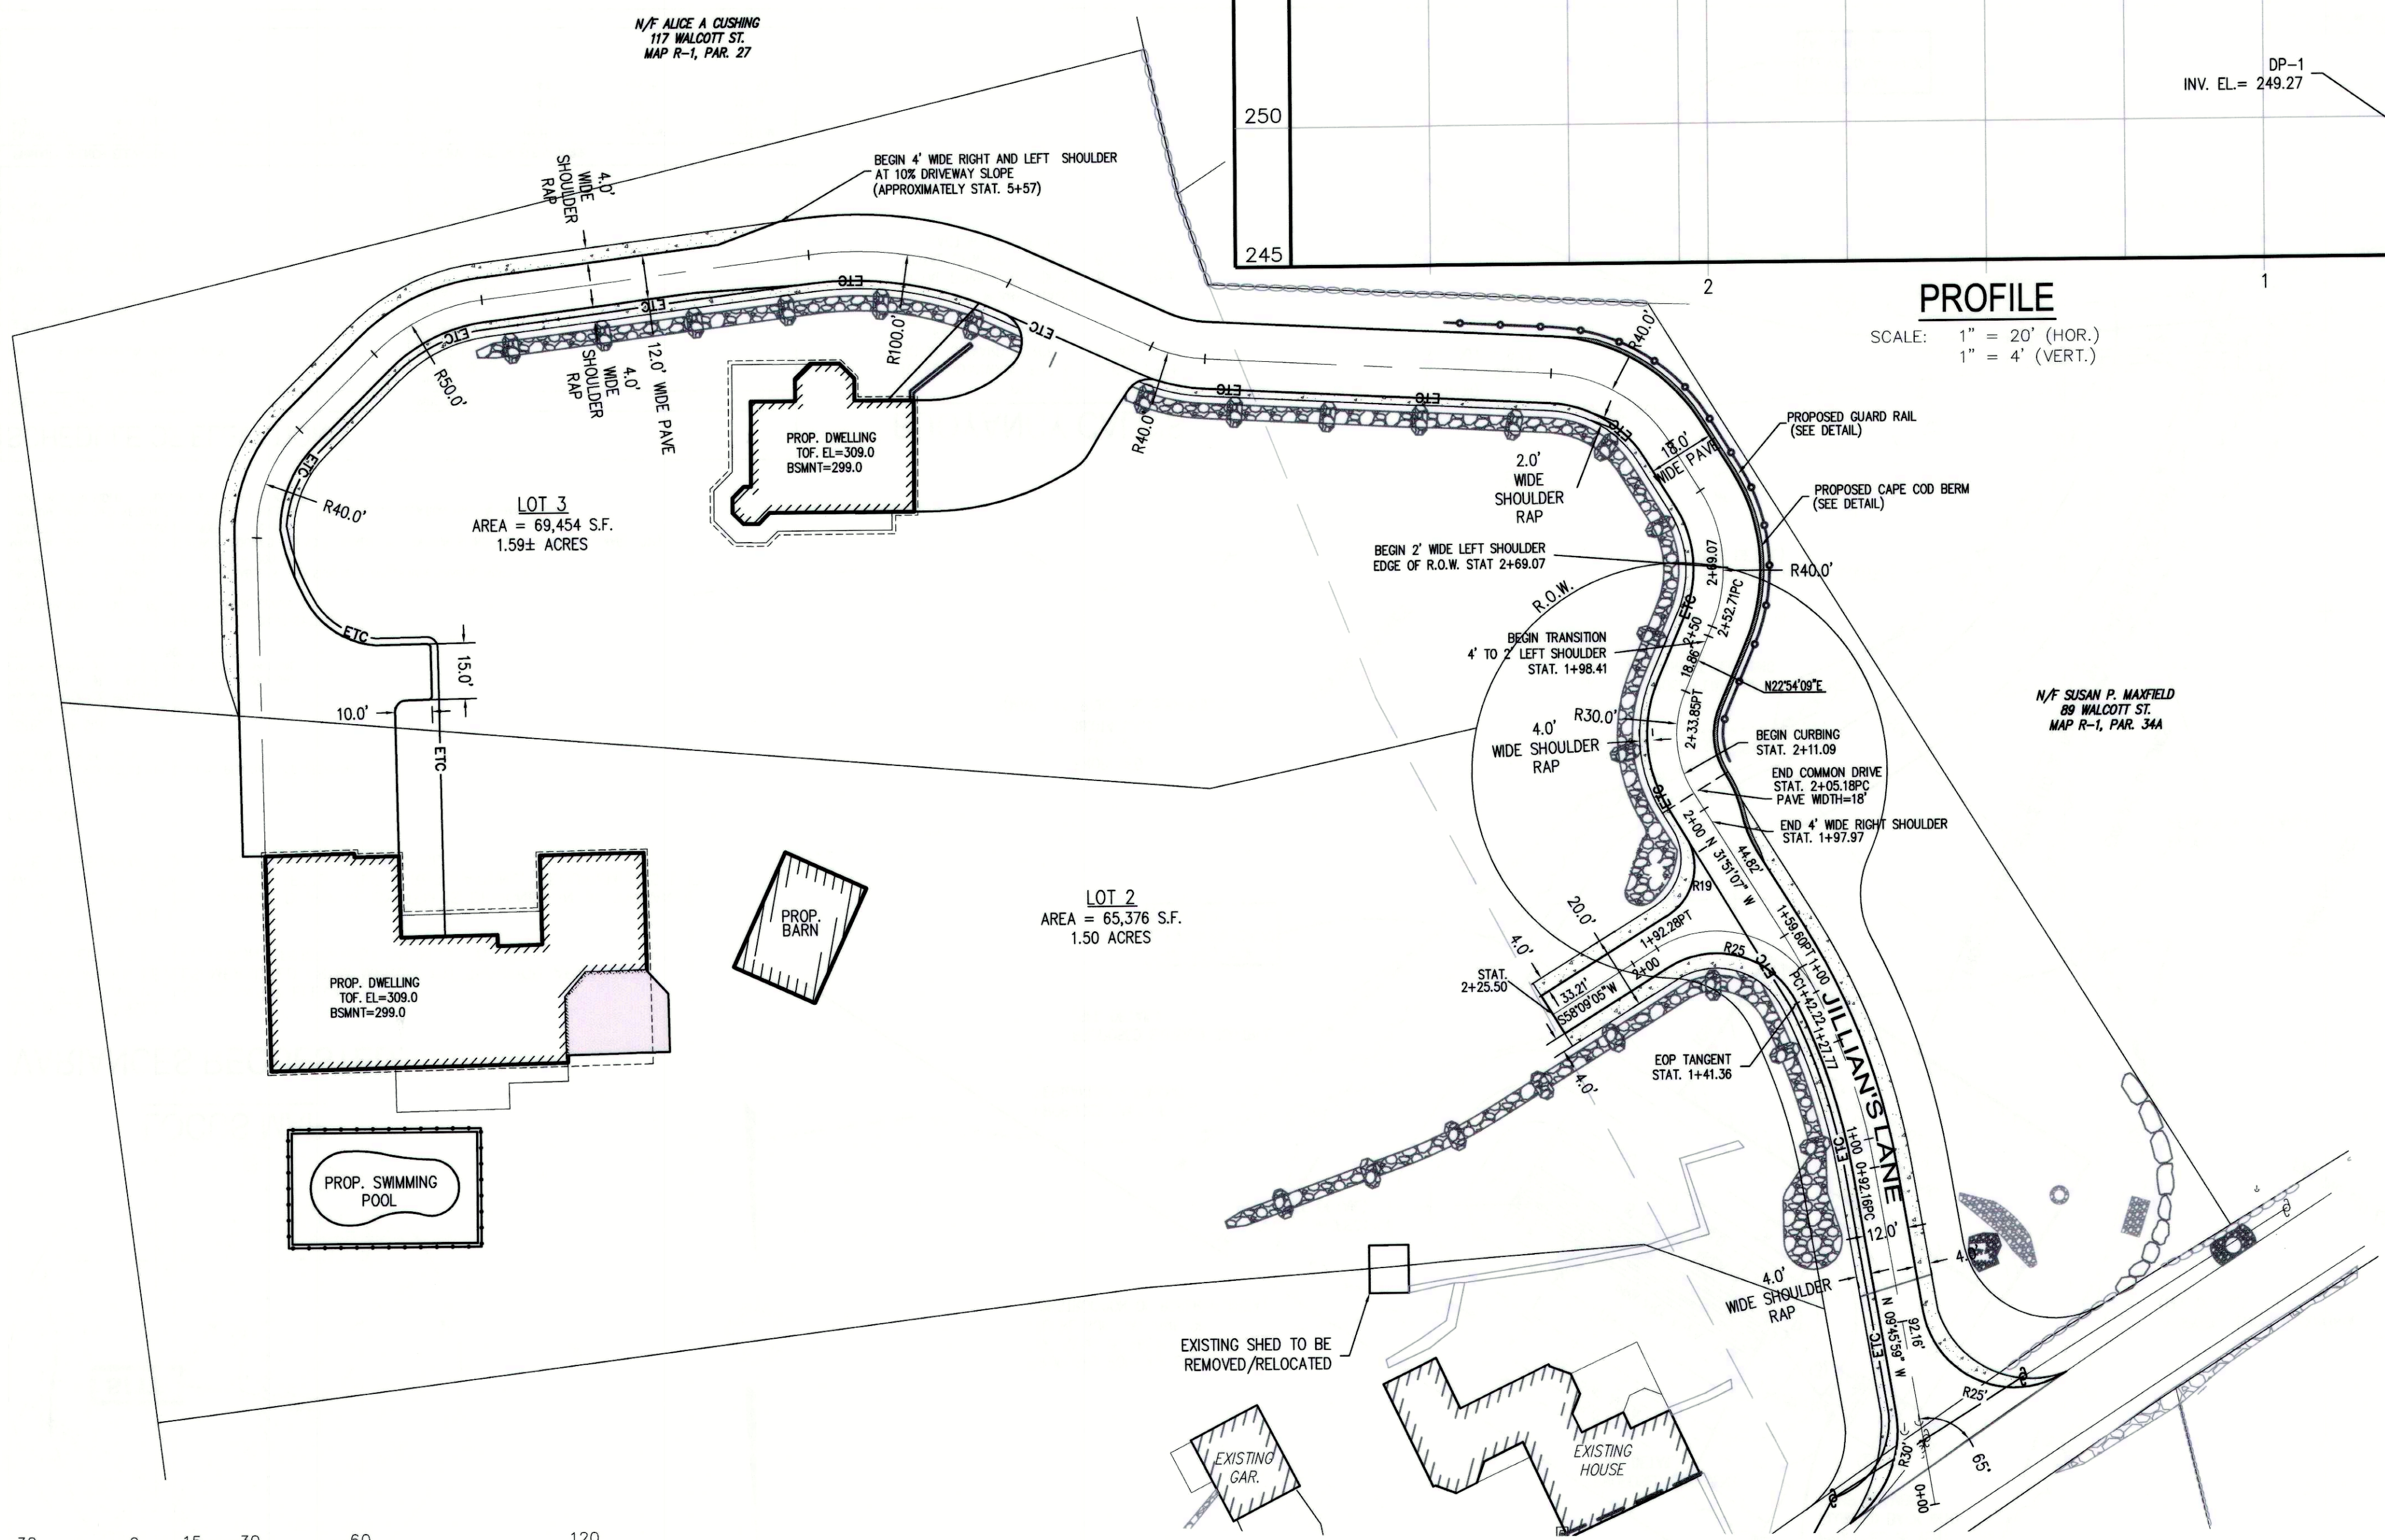

PLAN VIEW

SCALE: 1" = 30'

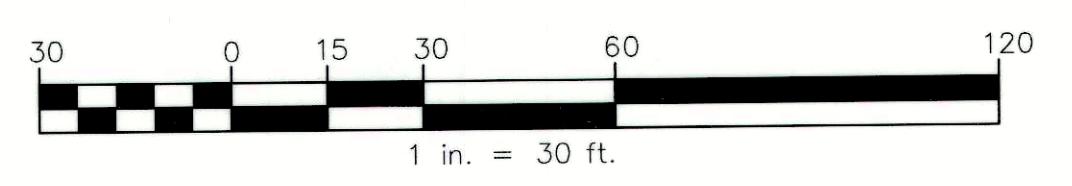

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PROFESSIONAL ENGINEER

PROFESSIONAL LAND SURVEYOR

RESERVED FOR REGISTRY USE

APPROVAL REQUIRED UNDER THE SUBDIVISION CONTROL LAW

DATE APPROVED: _____

BEING A MAJORITY OF THE STOW PLANNING BOARD

DATE ENDORSED: _____

APPROVED SUBJECT TO CONDITIONS SET FORTH IN A COVENANT EXECUTED BY _____ AND TO BE RECORDED HEREWITH DATED _____

NO BUILDING OR STRUCTURE SHALL BE BUILT OR PLACED ON ANY LOT WITHOUT A PERMIT FROM THE BOARD OF HEALTH

I, _____ CLERK OF THE TOWN OF _____ HEREBY CERTIFY THAT THE NOTICE OF THE APPROVAL OF THIS PLAN BY THE PLANNING BOARD HAS BEEN RECEIVED AND RECORDED BY THIS OFFICE AND NO APPEAL WAS RECEIVED DURING THE TWENTY (20) DAYS NEXT AFTER RECEIPT AND RECORDING OF SAID NOTICE.

STOW TOWN CLERK _____ DATE _____

ZONING CLASSIFICATION: RESIDENTIAL (RES)

STOW

HAMMERHEAD LOTS:

FRONTAGE = 50' SETBACKS: FRONT = 50'

LOT AREA = 180,000 SQ. FT. SIDE = 45'

OPEN SPACE (MIN.) = 10% REAR = 40'

FLOOR AREA RATIO = NR LOT SHAPE (MIN.) = 0.25

CONVENTIONAL LOTS:

FRONTAGE = 200' SETBACKS: FRONT = 30'

LOT AREA = 65,340 SQ. FT. SIDE = 25'

OPEN SPACE (MIN.) = 10% REAR = 40'

FLOOR AREA RATIO = NR LOT SHAPE (MIN.) = 0.40

OWNER: RICHARD F. RIEL 113 WALCOTT STREET STOW, MA 01775

APPLICANT: ROBERT VISCO 30 OLD STOW ROAD HUDSON, MA 01749

BOOK/PAGE: BOOK 13501, PAGE 418

MAP/PARCEL: MAP R-1, PARCEL 31

JILLIAN'S LANE

DEFINITIVE SUBDIVISION DEVELOPMENT

STOW, MASSACHUSETTS

PROFILE

NO.	DATE	DESCRIPTION	BY
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PREPARED BY:

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Civil Design Group, Inc.

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1092 MAIN STREET, P.O. BOX 428 BOLTON, MASSACHUSETTS 01740

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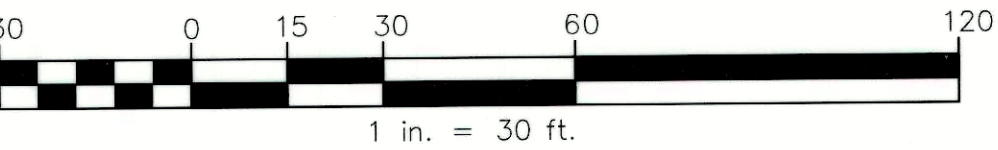
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GSR	GSR	GSR	5

DATE: 3/18/16

JOB NUMBER: 5139

DRAWING NO. 5139-PROF

OF 11



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INFILTRATION VOLUME SCHEDULE:

SEDIMENT FOREBAY AREA

ELEV	AREA	INC. VOL	TOTAL VOL.
248	30 SF	0 CF	0 CF
249	96 SF	60 CF	60 CF
250	200 SF	145 CF	205 CF
252.25	280 SF	60 CF	265 CF

INFILTRATION AREA

ELEV	AREA	INC. VOL.	TOTAL VOL.
248	390 SF	0 CF	0 CF
250	1,355 SF	1,648 CF	1,648 CF
252	3,090 SF	4,327 CF	5,975 CF
253	3,567 SF	3,326 CF	9,301 CF

ROOF INFILTRATION FORMULA

REQUIRED NUMBER OF INFILTRATION CHAMBERS PER ROOF AREA SHALL BE DETERMINED BY THE FOLLOWING FORMULA, ROUNDING UP TO THE NEXT WHOLE NUMBER:

$$\text{ROOF AREA (S.F.)} / 185 = \text{NO. OF CULTCH CHAMBERS, MODEL C-100HD}$$

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I CERTIFY THIS PLAN CONFORMS
TO THE RULES AND REGULATIONS
OF THE REGISTERS OF DEEDS OF THE
COMMONWEALTH OF MASSACHUSETTS

APPROVAL REQUIRED UNDER THE SUBDIVISION CONTROL LAW
DATE APPROVED: _____

BEING A MAJORITY
OF THE STOW
PLANNING BOARD

DATE ENDORSED: _____

APPROVED SUBJECT TO CONDITIONS SET FORTH
IN A COVENANT EXECUTED BY _____
DATED _____ AND TO BE RECORDED HERewith

NO BUILDING OR STRUCTURE SHALL BE BUILT OR PLACED ON ANY LOT
WITHOUT A PERMIT FROM THE BOARD OF HEALTH

I, _____, CLERK OF THE TOWN OF
HEREBY CERTIFY THAT THE NOTICE OF THE APPROVAL OF THIS PLAN BY THE
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STOW TOWN CLERK _____ DATE _____

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HAMMERHEAD LOTS:

FRONTAGE = 50'
LOT AREA = 180,000 SQ. FT.
OPEN SPACE (MIN.) = 10%
FLOOR AREA RATIO = NR

CONVENTIONAL LOTS

FRONTAGE = 200'
LOT AREA = 65,340 SQ. FT.
OPEN SPACE (MIN.) = 10%
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BOOK/PAGE:
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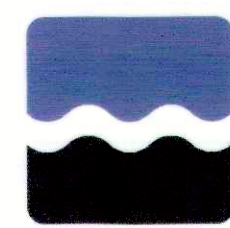
APPLICANT: ROBERT VISCO
30 OLD STOW ROAD
HUDSON, MA 01749

MAP/PARCEL:
MAP R-1, PARCEL 31

JILLIAN'S LANE
DEFINITIVE SUBDIVISION DEVELOPMENT
STOW, MASSACHUSETTS
GRADING PLAN

NO.	DATE	DESCRIPTION	BY
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DESIGN BY: GSR	DRAWN BY: GSR	CHECKED BY: G
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DATE:	JOB NUMBER:	DRAWING NO.
3/18/16	5139	5139-GRAB

OF 1

EROSION CONTROL NOTES/SPECIFICATIONS:

A. MANAGEMENT STRATEGIES:

1. CONTRACTOR TO COMPLY WITH THE REQUIREMENT OF THE STORMWATER POLLUTION PREVENTION PLAN (SWPPP) WHICH IS REQUIRED TO BE FILED PRIOR TO CONSTRUCTION.
2. CONSTRUCTION SHALL BE SEQUENCED SO THAT GRADING OPERATIONS CAN BEGIN AND END AS QUICKLY AS POSSIBLE.
3. EROSION CONTROL MEASURES SHALL BE INSTALLED PRIOR TO ANY DISTURBANCE ON SITE.
4. AREAS WHICH ARE NOT TO BE DISTURBED SHALL BE CLEARLY MARKED BY FLAGS, SIGNS, ETC. RETAIN EXISTING VEGETATION WHERE FEASIBLE.
5. THERE SHALL BE NO STORAGE OF ANY KIND OF ANY CHEMICALS, PESTICIDES, FUELS AND OTHER POTENTIALLY TOXIC OR HAZARDOUS MATERIALS ON SITE.
6. NO DEBRIS, JUNK, RUBBISH OR OTHER WASTE MATERIALS SHALL BE BURIED ON THE SITE.
7. STUMPS AND OTHER WOOD DEBRIS SHALL BE DISPOSED OF IN ACCORDANCE WITH THE "POLICY ON THE DISPOSAL OF WOOD WASTES" PUBLISHED BY THE DEPARTMENT OF ENVIRONMENTAL AFFAIRS, DATED AUGUST 14, 1987.
8. THE JOB SUPERINTENDENT SHALL BE RESPONSIBLE FOR THE INSTALLATION AND MAINTENANCE OF ALL EROSION AND SEDIMENT CONTROL PRACTICES.

B. MAINTENANCE/ PERFORMANCE STANDARDS:

1. SAND, DIRT, OR DEBRIS, OR DEBRIS WHICH ERODE FROM THE SUBDIVISION ONTO ANY PUBLIC STREET OR PRIVATE PROPERTY SHALL BE CLEANED UP. ANY SILT OR OTHER DEBRIS THAT ENTER ANY EXISTING DRAINAGE SYSTEM INCLUDING CATCHBASIN PUMPS, PIPE LINES, MANHOLES AND DITCHES SHALL BE REMOVED.
2. ALL EROSION AND SEDIMENTATION CONTROL MEASURES SHALL BE INSPECTED WEEKLY AND AFTER EACH RAINFALL WITH AN ACCUMULATION OF $\frac{1}{2}$ " OR MORE. THE FOLLOWING ITEMS SHALL BE CHECKED IN PARTICULAR:
 - a. THE SILT FENCE BARRIERS SHALL BE CHECKED REGULARLY FOR TEARS, DETERIORATION, AND UNDERMINING.
 - b. ALL SEEDED AREAS SHALL BE CHECKED REGULARLY TO SEE THAT A GOOD STAND IS MAINTAINED. AREAS SHOULD BE RESEED AS NEEDED.
 - c. ALL AREAS ON SITE SUBJECT TO EROSION/SEDIMENTATION SHALL BE INSPECTED ON A REGULAR BASIS. ALL ITEMS SPECIFIED ON THIS AND OTHER PLANS SHALL BE INSPECTED TO VERIFY THAT THEY ARE OPERATING AS DESIGNED AND INTENDED. IT SHALL BE THE CONTRACTORS RESPONSIBILITY TO MAINTAIN AND REPAIR ALL STRUCTURES.
 - d. THE ENTIRE DRAINAGE SYSTEM SHALL BE INSPECTED ON A REGULAR BASIS AND PRIOR TO AND IMMEDIATELY AFTER ANY RAINFALL EVENT WHILE THE SITE IS DISTURBED.
3. CATCH BASIN SHALL BE INSPECTED WEEKLY TO ENSURE IT IS WATER TIGHT, HAS ADEQUATE SUMP CAPACITY, THAT OIL AND GAS TRAPS ARE IN PLACE. IT SHALL ALSO BE INSPECTED AFTER EVERY SIGNIFICANT RAINFALL EVENT (I.E. A TWO-YEAR STORM EVENT OR GREATER) DURING THE FIRST THREE (3) MONTHS OF BEING PLACED IN SERVICE TO ENSURE THAT IT IS FUNCTIONING IN AN ADEQUATE FASHION. THE BASIN SHALL BE CLEANED WITH A VACUUM TRUCK WHEN $\frac{1}{2}$ OF THE SUMP IS FILLED WITH SEDIMENT BUT NOT LESS THAN TWO (2) TIMES PER YEAR. AFTER THE FIRST THREE (3) MONTHS OF SERVICE THE BASIN SHALL BE INSPECTED NOT LESS THAN ONE (1) TIME PER YEAR TO ENSURE ADEQUATE FUNCTIONALITY. OIL/GAS TRAPS SHALL BE CLEANED WITH A VACUUM TRUCK AND MONITORED FOR HYDROCARBON BUILD UP SEMIANNUALLY.
4. DRAINAGE SWALES DURING CONSTRUCTION SHALL BE INSPECTED MONTHLY FOR EROSION, SEDIMENT ACCUMULATION AND LEAF BUILDUP. ALL ERODED AREAS SHALL BE STABILIZED. SEDIMENT SHALL BE REMOVED AND LEAF LITTER REMOVED.
5. DEWATERING OF EXCAVATIONS DURING CONSTRUCTION SHALL BE ADDRESSED ON AN INDIVIDUAL BASIS AS NEEDED. IF TEMPORARY DEWATERING IS REQUIRED ON THE SITE, SEDIMENT BASINS SHALL BE CONSTRUCTED OR GEOTEXTILE FABRIC FILTER BAGS SHALL BE UTILIZED. FILTER BAGS AND SEDIMENT BASINS SHALL BE MAINTAINED DURING THE DEWATERING OPERATION.
6. EXISTING DRAINAGE STRUCTURES DOWN GRADIENT OF THE SITE SHALL BE INSPECTED AND CLEANED IF NECESSARY PRIOR TO CONSTRUCTION. PROOF OF SUCH CLEANING SHALL BE PROVIDED TO THE CONSERVATION COMMISSION. EXISTING STRUCTURES SHALL BE INSPECTED MONTHLY AND AFTER EVERY RAIN EVENT WHILE THE SITE IS DISTURBED. STRUCTURES SHALL BE CLEANED AS REQUIRED.
7. EXTREME WEATHER - IN ADVANCE OF FORECASTED HEAVY RAIN EVENTS, TEMPORARY MEASURES SUCH AS CHECK DAMS, DIVERSION TRENCHES, DOUBLED-UP EROSION CONTROL DOWN GRADIENT OF DISCHARGE POINTS AND UNSTABLE SURFACES SHALL BE UTILIZED UNTIL THE SITE IS STABILIZED. SILT SACKS INSTALLED IN DRAINAGE STRUCTURES SHALL BE CLEANED PRIOR TO THE EVENT. CONTRACTOR IS RESPONSIBLE FOR MAINTAINING EROSION CONTROLS DURING EXTREME EVENTS WHICH MAY REQUIRE STAFFED ONSITE INSPECTIONS AND REMEDIAL ACTIONS DURING THE STORM EVENT.
8. CONTRACTOR SHALL MAINTAIN A STOCKPILE OF ADDITIONAL EROSION CONTROL MEASURES ON SITE THROUGHOUT CONSTRUCTION. SUCH MEASURES ARE TO INCLUDE STRAW BALES, WATTLES, SILT FENCE, GEOTEXTILE FILTER BAGS, CRUSHED STONE AND STUMP GRINDINGS.

C. TEMPORARY MEASURES:


1. PLACE SILT FENCES AS SHOWN ON THE EROSION CONTROL PLAN. SILT FENCES SHALL BE DOUBLED UP, SEPARATED BY 1'-2". SEDIMENT SHALL BE REMOVED ONCE THE VOLUME REACHES $\frac{1}{4}$ OF THE HEIGHT OF SILT FENCE OR STRAW BALES.
2. PLACE CHECK DAMS IN SWALES AND ON EXPOSED ROAD SECTIONS AS REQUIRED BY THE TOWN OF STOW REGULATIONS.
3. DURING DRY PERIODS, PROVIDE MEANS FOR MITIGATION OF DUST, SUCH AS WATERING OF EXPOSED AREAS.
4. PROTECT CATCH BASIN WITH SEDIMENT TRAPS AS SHOWN.
5. IF LOAM IN PLACED OUTSIDE OF THE NORMAL GROWING SEASON SILT FENCE OR STRAW WADDLES SHALL BE PLACED BETWEEN THE LAWN AREA AND PAVEMENT.
6. DURING DRY PERIODS, PROVIDE MEANS FOR MITIGATION OF DUST, SUCH AS WATERING OF EXPOSED AREAS.
7. STOCKPILE LOCATIONS SHALL BE WITHIN THE PROPOSED LIMIT OF WORK. PLACE SILT FENCE AROUND ALL STOCK PILE AREAS. PILES LEFT FOR 21 DAYS OR MORE SHALL BE SEED OR COVER WITH PLASTIC SHEETING.
8. WASTE DISPOSAL RECEPTACLES AND TRAILERS WILL BE USED FOR THE DISPOSAL OF CONSTRUCTION DEBRIS, WHICH WILL BE REMOVED FROM SITE ACCORDING TO STATE, LOCAL AND FEDERAL GUIDELINES. CONSTRUCTION DEBRIS WILL INCLUDE PAVEMENT, UTILITY, EARTH AND BUILDING MATERIALS THAT CANNOT BE REUSED. THE RECEPTACLES WILL BE LOCATED ON-SITE AND COVERED.
9. A COMBINATION OF THE USE OF STUMP GRINDINGS, WINTER RYE PLANTINGS, EROSION CONTROL MATS, AND DENSE MAT OF STRAW MULCH WITH TACKIFIER ETC. SHALL BE USED IN THE EVENT THE VEGETATION IS NOT FULLY ESTABLISHED BY THE ONSET OF WINTER.

D. PERMANENT STABILIZATION:


1. SLOPES FLATTER THAN 3 TO 1 SHALL BE LOAMED (6" MIN.) AND HYDROSEED (WITH MULCH & TACKIFIER). SLOPES SHALL BE MONITORED FOR SIGNS OF WASHOUT. PROVIDE ADDITIONAL MULCHING OR OTHER ACCEPTABLE SLOPE PROTECTION AS REQUIRED UNTIL VEGETATION IS ESTABLISHED.
2. SLOPES 3:1 OR GREATER SHALL BE RESTORED WITH 6" OF LOAM (MIN.), HYDROSEED (WITH MULCH & TACKIFIER) AND STAKED DOWN EROSION CONTROL BLANKET SIMILAR TO NORTH AMERICAN GREEN SC 150 BN. INSTALL IN ACCORDANCE WITH THE MANUFACTURERS INSTRUCTIONS.
3. UNLESS OTHERWISE INDICATED HEREON ALL DISTURBED AREAS SHALL BE LOAMED (6" MIN.) AND HYDROSEED (WITH MULCH & TACKIFIER). AREAS NOT STABILIZED BEFORE THE END OF THE FALL PLANTING SEASON SHALL BE STABILIZED WITH MULCH, THEN HYDROSEED IN THE SPRING.
4. STABILIZE ALL PONDS. BOTTOM AND SIDE SLOPES OF PONDS SHALL BE STABILIZED WITHIN ONE WEEK OF COMPLETION OF ROUGH GRADING. OUTFALLS SHALL BE STABILIZED WITHIN ONE WEEK OF PIPE PLACEMENT.
5. THE TEMPORARY MEASURES WILL NOT BE REMOVED UNTIL PERMANENT STABILIZATION HAS OCCURRED.
6. PHOSPHORUS CONTAINING FERTILIZER MAY ONLY BE APPLIED TO LAWN OR NON-AGRICULTURAL TURF WHEN
 - i. (i) A SOIL TEST INDICATES THAT ADDITIONAL PHOSPHORUS IS NEEDED FOR THE GROWTH OF THAT LAWN OR NON-AGRICULTURAL TURF; OR
 - ii. (ii) IS USED FOR NEWLY ESTABLISHED LAWN OR NON-AGRICULTURAL TURF DURING THE FIRST GROWING SEASON.
7. SEED MIX SHALL CONSIST OF LAWPRO MIX BY PRO-LAWN SUPPLY OR EQUAL, CONSISTING OF 35% PERENNIAL RYE, 35% CREEPING RED FESCUE, AND 30% KENTUCKY BLUE GRASS.
8. SEED MIX IN THE AREA OF THE DETENTION BASIN SHALL CONSIST OF "NEW ENGLAND EROSION CONTROL/RESTORATION MIX FOR DETENTION BASIN AND MOIST" AS DESIGNED BY NEW ENGLAND WETLAND PLANTS, INC.
9. SEED MIX IN THE AREAS ALONG THE COMMON DRIVEWAY ON SLOPES GREATER THEN 3:1 SHALL CONSIST OF "NEW ENGLAND ROADSIDE MATRIX UPLAND SEED MIX" AS DESIGNED BY NEW ENGLAND WETLAND PLANTS, INC.

E. CONSTRUCTION SEQUENCE:

1. DURING THIS SEQUENCE ALL EROSION CONTROLS SHALL BE INSPECTED AND MAINTAINED. ALL DISTURBED AREAS SHALL BE STABILIZED BY SEEDING OR SODDING AS SOON AS POSSIBLE AFTER GRADING IS COMPLETE. EROSION BARRIERS SHALL BE REMOVED AFTER SLOPE STABILIZATION IS COMPLETE.
2. UPGRADE CULVERT ALONG WALCOTT STREET PRIOR TO ANY SITE WORK.
3. INSTALL EROSION AND SEDIMENT CONTROL MEASURES.
4. INSTALL DRY DETENTION BASIN AND MAINTAIN THROUGHOUT CONSTRUCTION.
5. TREE CLEARING, GRUBBING AND STUMP REMOVAL.
6. EXCAVATE TO FOUNDATION IN CUT SECTIONS; BRING FILL SECTIONS TO SUBGRADE USING EXCAVATED SOIL.
7. INSTALL ROAD GRAVEL.
8. PLACE BINDER COURSE FOR ROADWAY.
9. FINISH GRADE SWALES AND INFILTRATION BASINS.
10. LOAM, SEED AND MULCH DISTURBED AREAS INCLUDING SWALES.
11. PLANT TREES, SHRUBS AND GROUND COVER AS INDICATED ON PLANS.

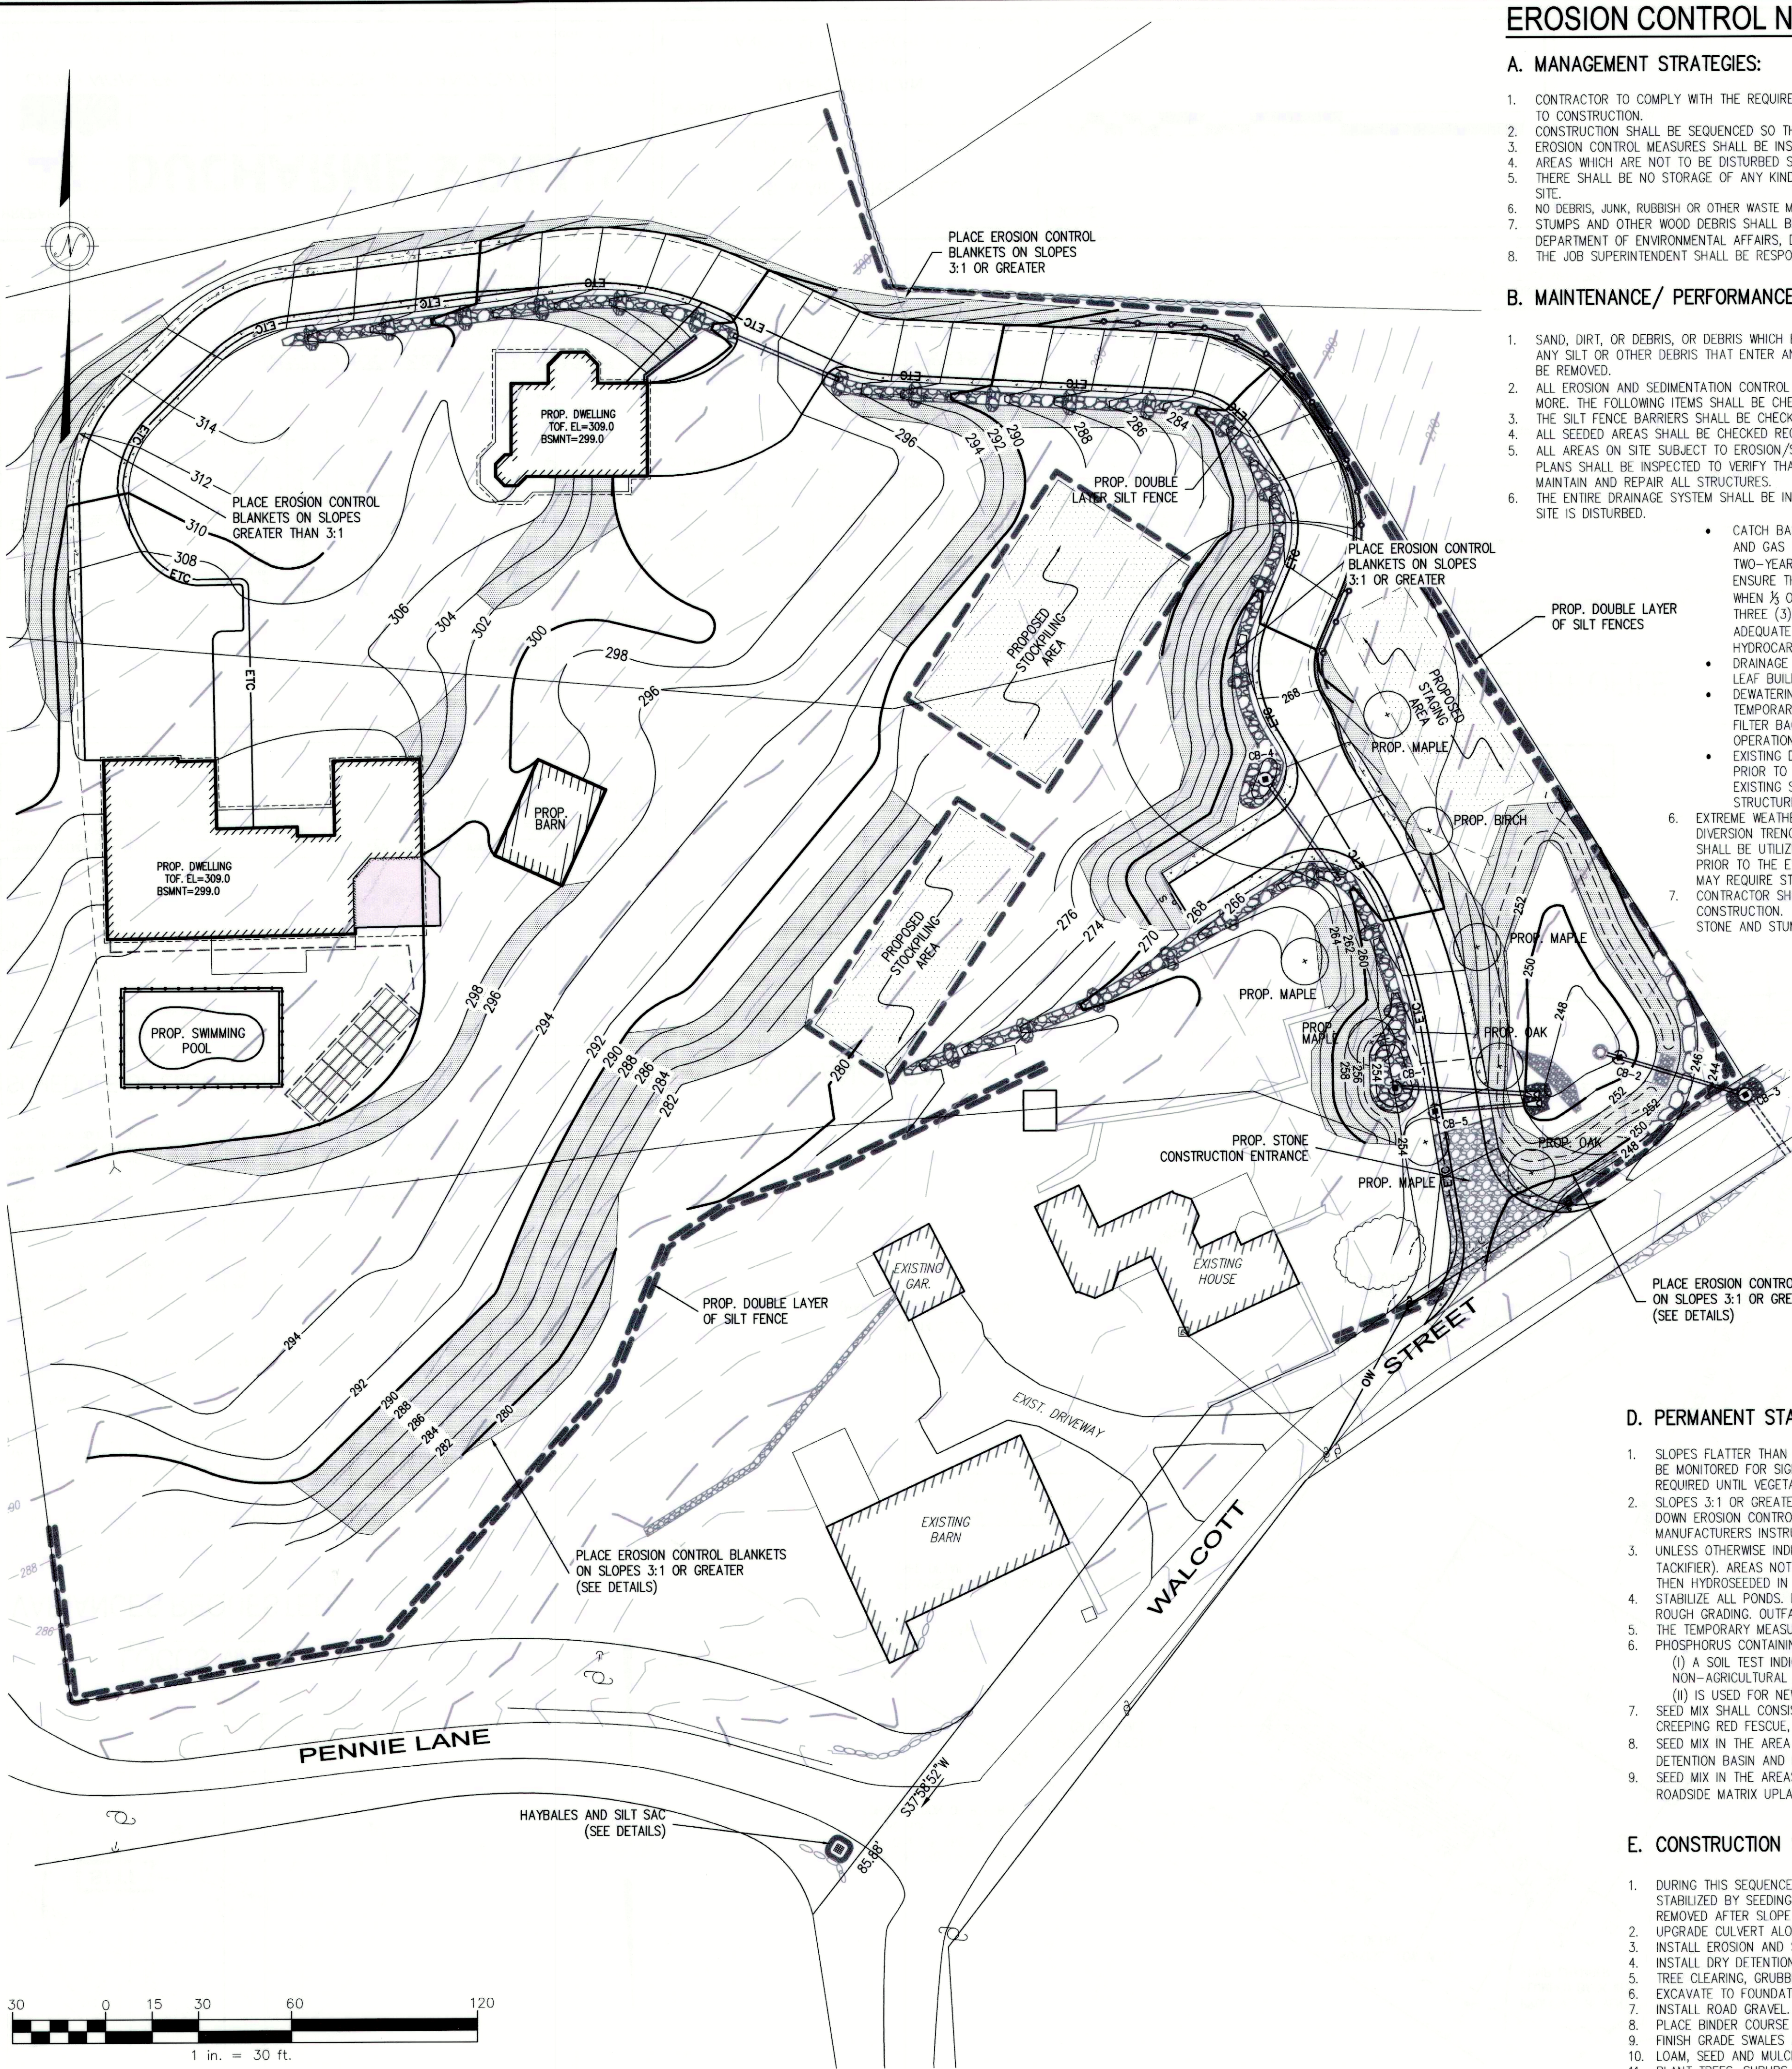

RESERVED FOR REGISTRY USE

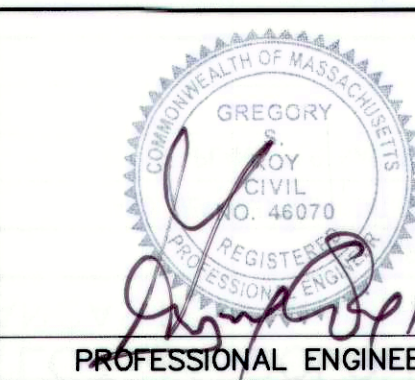

I CERTIFY THIS PLAN CONFORMS TO THE RULES AND REGULATIONS OF THE REGISTERS OF DEEDS OF THE COMMONWEALTH OF MASSACHUSETTS

APPROVAL REQUIRED UNDER THE SUBDIVISION CONTROL LAW
DATE APPROVED: _____

BEING A MAJORITY OF THE STOW PLANNING BOARD

DATE ENDORSED: _____

APPROVED SUBJECT TO CONDITIONS SET FORTH IN A COVENANT EXECUTED BY _____ DATED _____ AND TO BE RECORDED HEREWITH

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I, _____ CLERK OF THE TOWN OF STOW, HEREBY CERTIFY THAT THE NOTICE OF THE APPROVAL OF THIS PLAN BY THE PLANNING BOARD HAS BEEN RECEIVED AND RECORDED BY THIS OFFICE AND NO APPEAL WAS RECEIVED DURING THE TWENTY (20) DAYS NEXT AFTER RECEIPT AND RECORDING OF SAID NOTICE.

STOW TOWN CLERK _____ DATE _____

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HAMMERHEAD LOTS:
FRONTAGE = 50'
LOT AREA = 180,000 SQ. FT.
OPEN SPACE (MIN.) = 10%
FLOOR AREA RATIO = NR
SETBACKS: FRONT = 50'
SIDE = 45'
REAR = 40'
LOT SHAPE (MIN.) = 0.25

CONVENTIONAL LOTS:
FRONTAGE = 200'
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OPEN SPACE (MIN.) = 10%
FLOOR AREA RATIO = NR
SETBACKS: FRONT = 30'
SIDE = 25'
REAR = 40'
LOT SHAPE (MIN.) = 0.40

OWNER: RICHARD F. RIEL
113 WALCOTT STREET
STOW, MA 01775
APPLICANT: ROBERT VISCO
30 OLD STOW ROAD
HUDSON, MA 01749

BOOK/PAGE: BOOK 13501, PAGE 418
MAP/PARCEL: MAP R-1, PARCEL 31

JILLIAN'S LANE
DEFINITIVE SUBDIVISION DEVELOPMENT
STOW, MASSACHUSETTS
EROSION CONTROL PLAN


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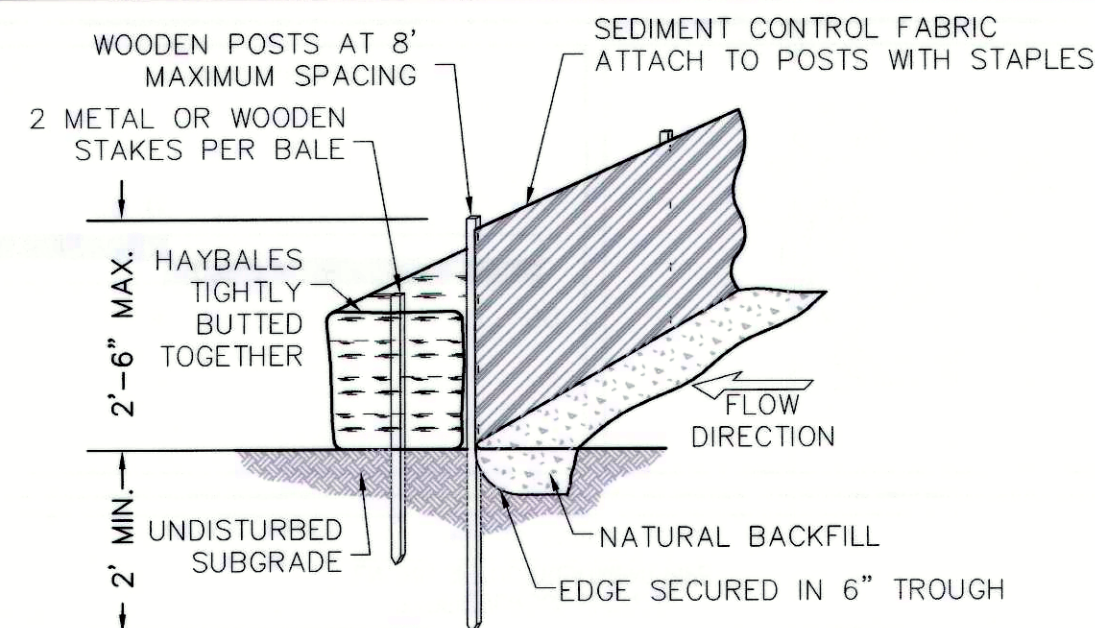
1092 MAIN STREET, P.O. BOX 428
BOLTON, MASSACHUSETTS 01740
PHONE: (978) 779-6091 FAX: (978) 779-0260
www.DucharmeandDillis.com

DESIGN BY:	DRAWN BY:	CHECKED BY:	SHEET NO.
GSR	GSR	GSR	7
DATE:	JOB NUMBER:	DRAWING NO.	OF 11
3/18/16	5139	5139-ECF	


TEMP. CONSTRUCTION ENTRANCE DETAIL



NOT TO SCALE

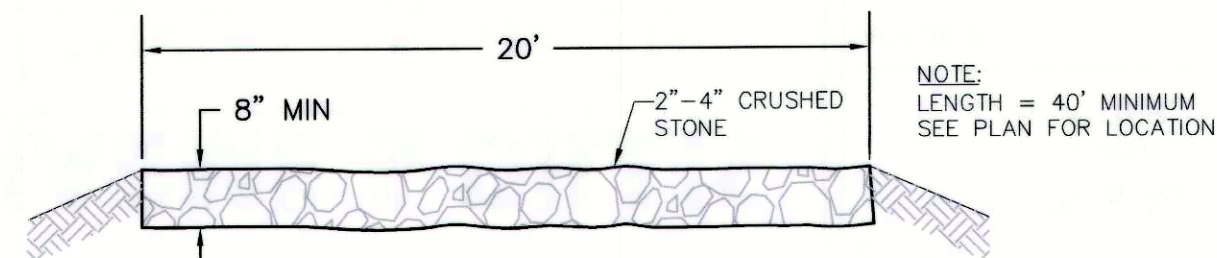


SILTATION BARRIER

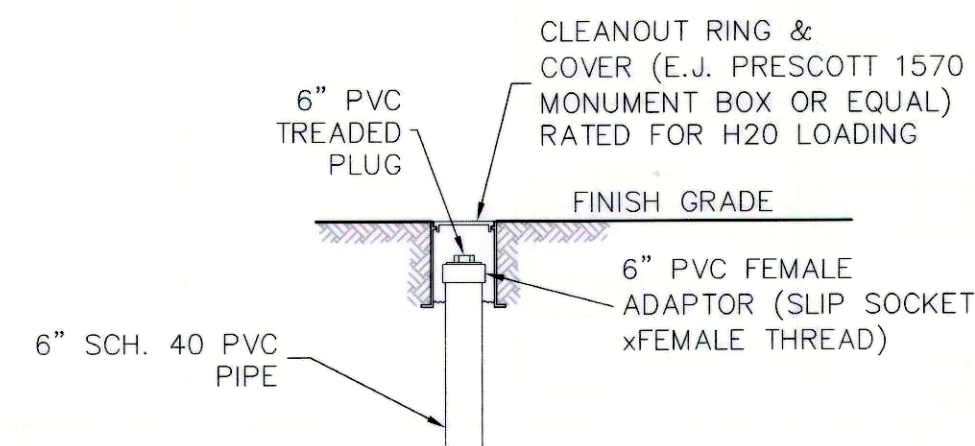


OBSERVATION PORT DETAIL

NOT TO SCALE

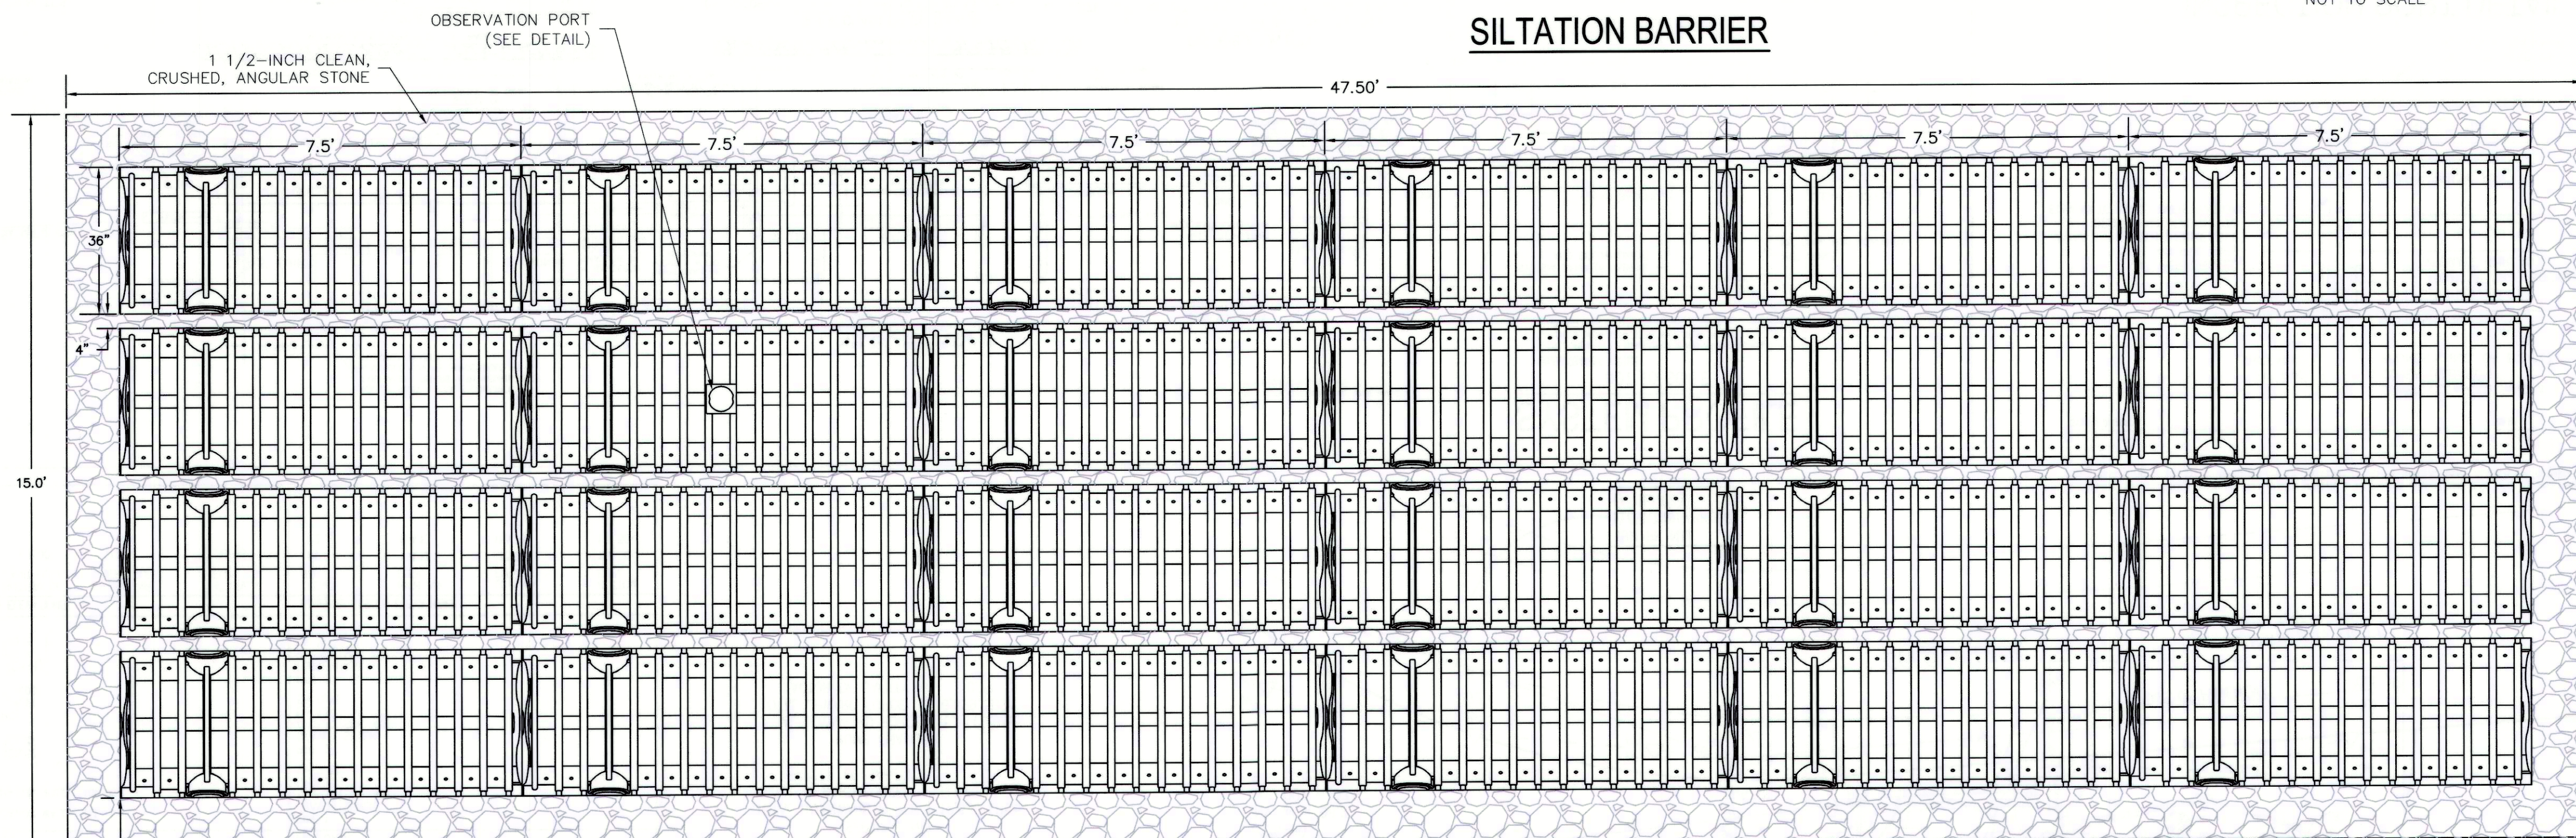


INFILTRATION PLAN VIEW

NOT TO SCALE

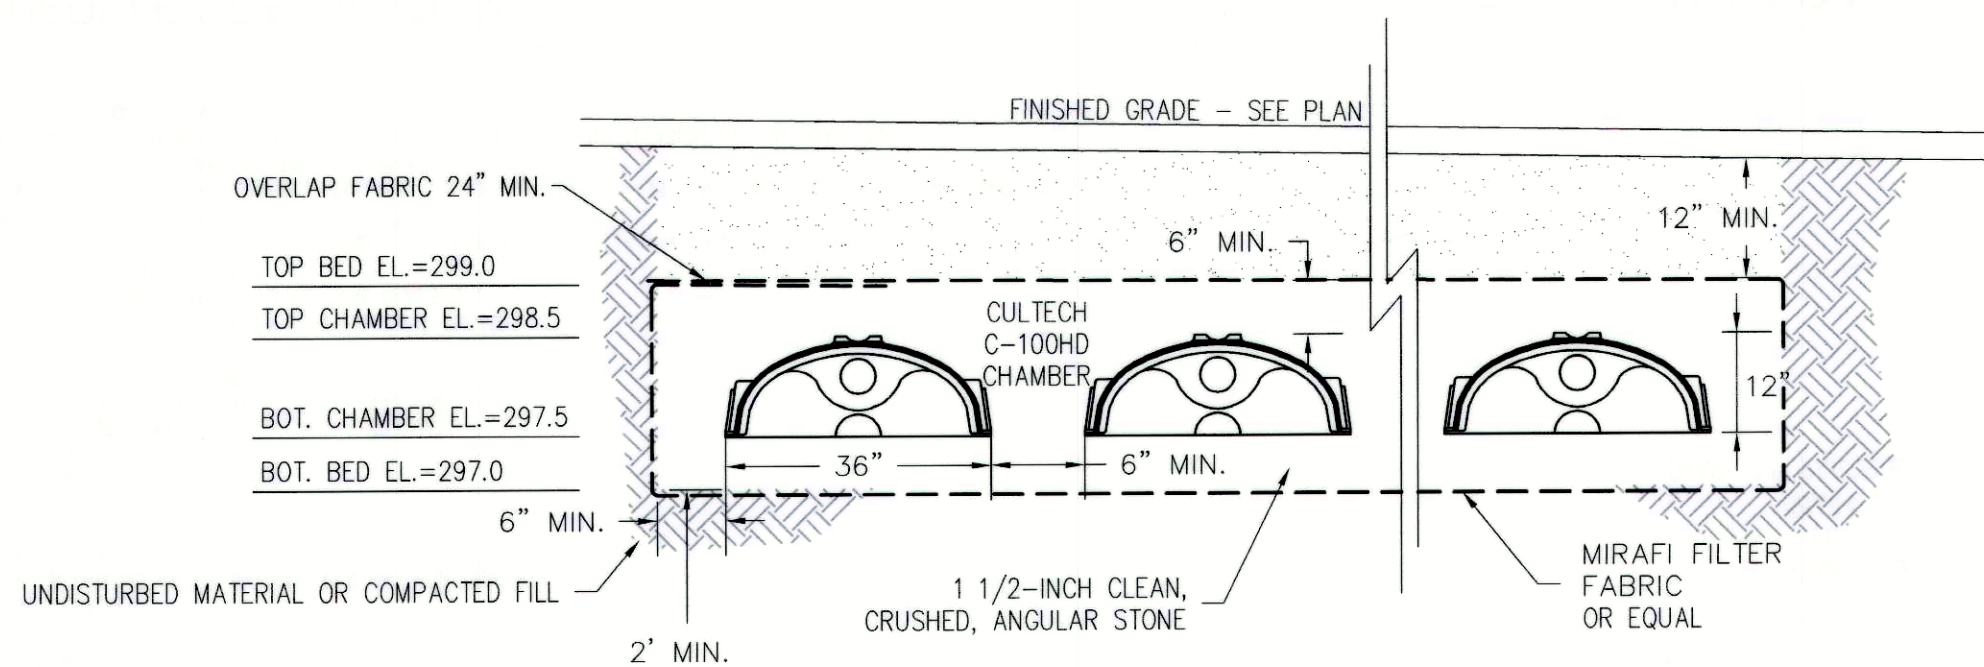


INFILTRATION PROFILE

NOT TO SCALE

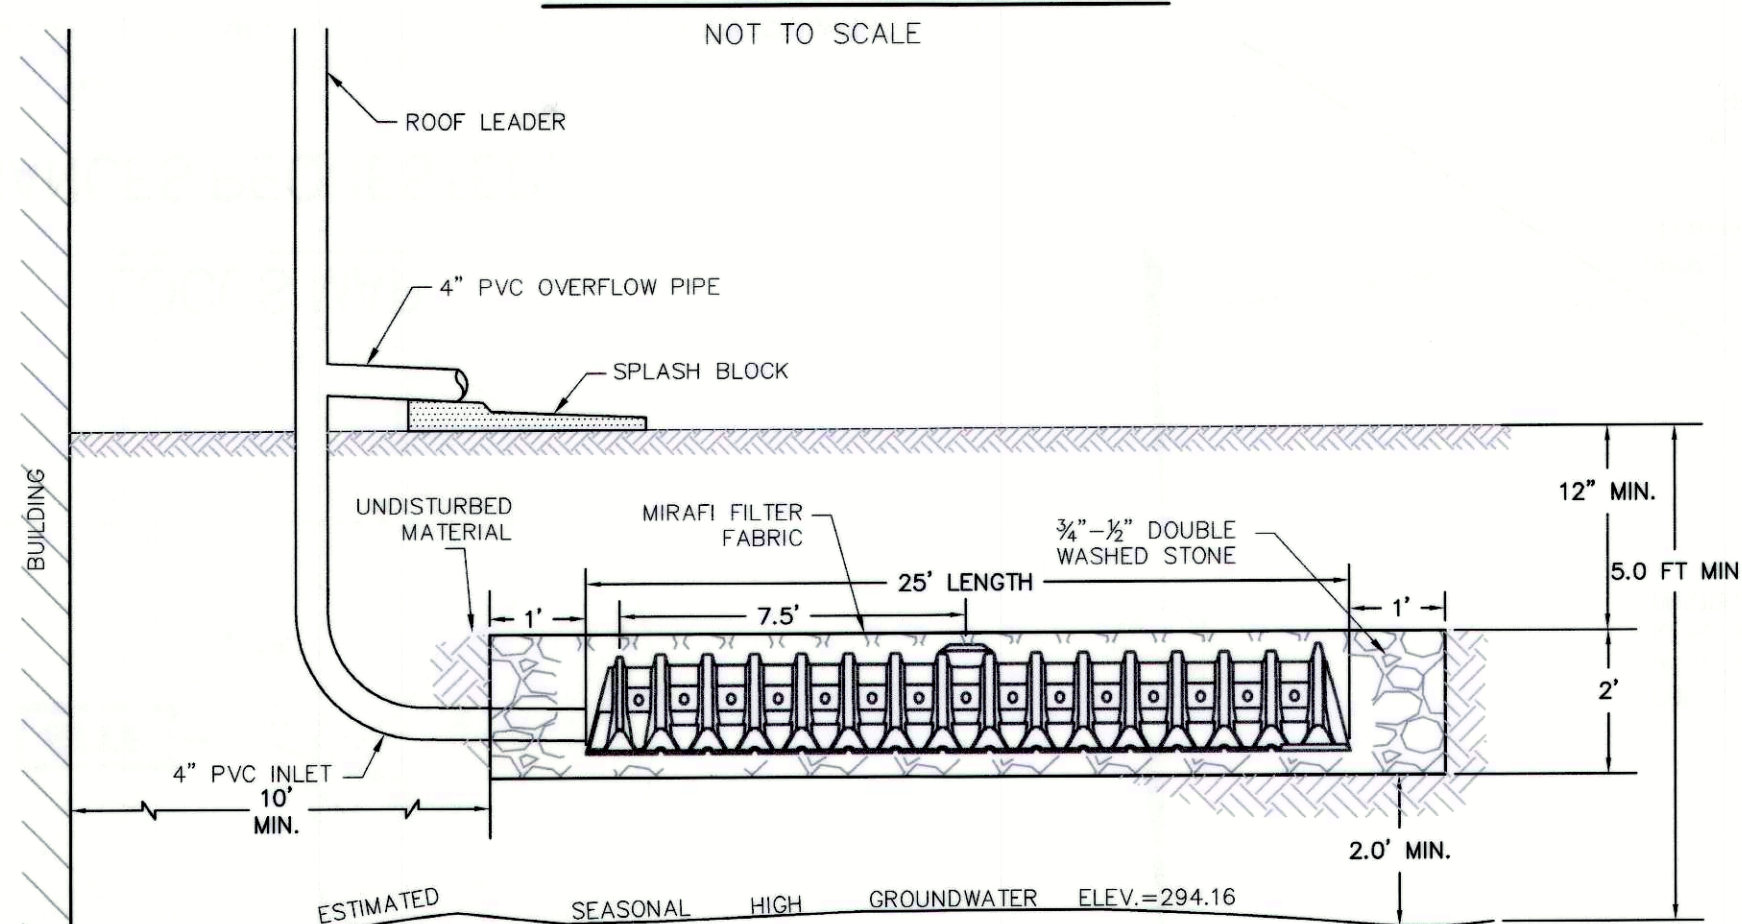


INFILTRATION PROFILE

NOT TO SCALE

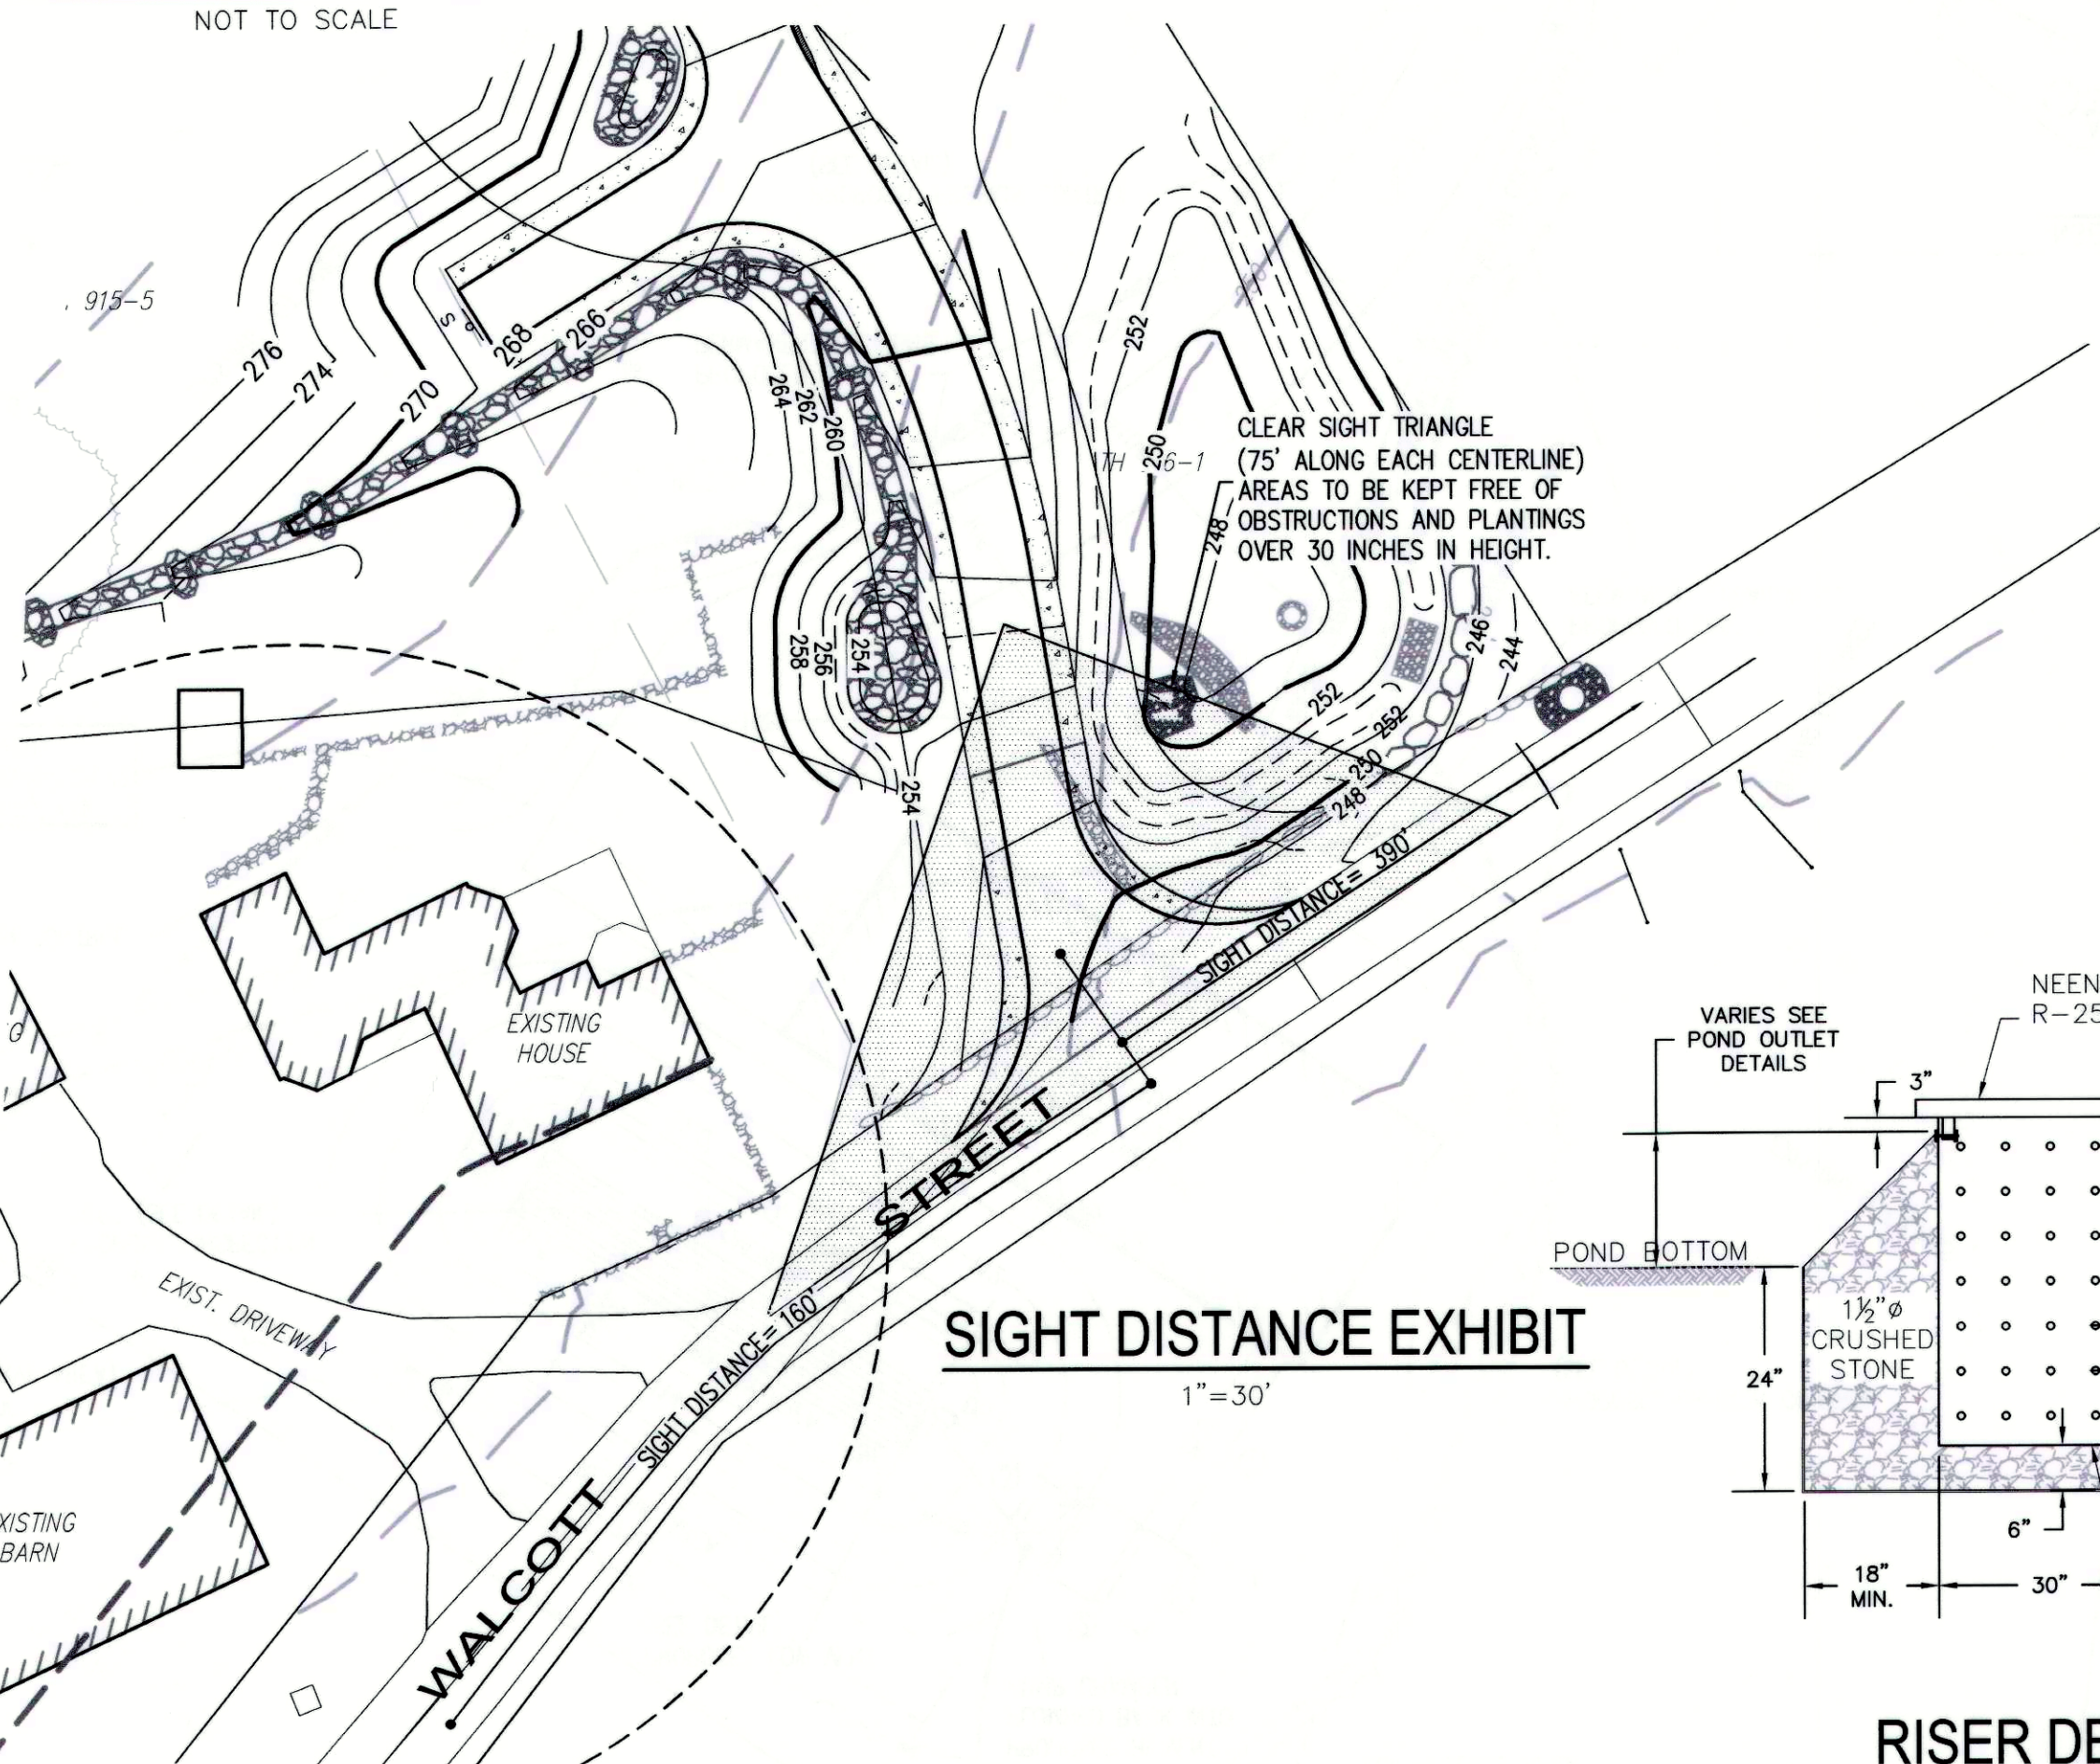

SIGHT DISTANCE EXHIBIT

1" = 30'

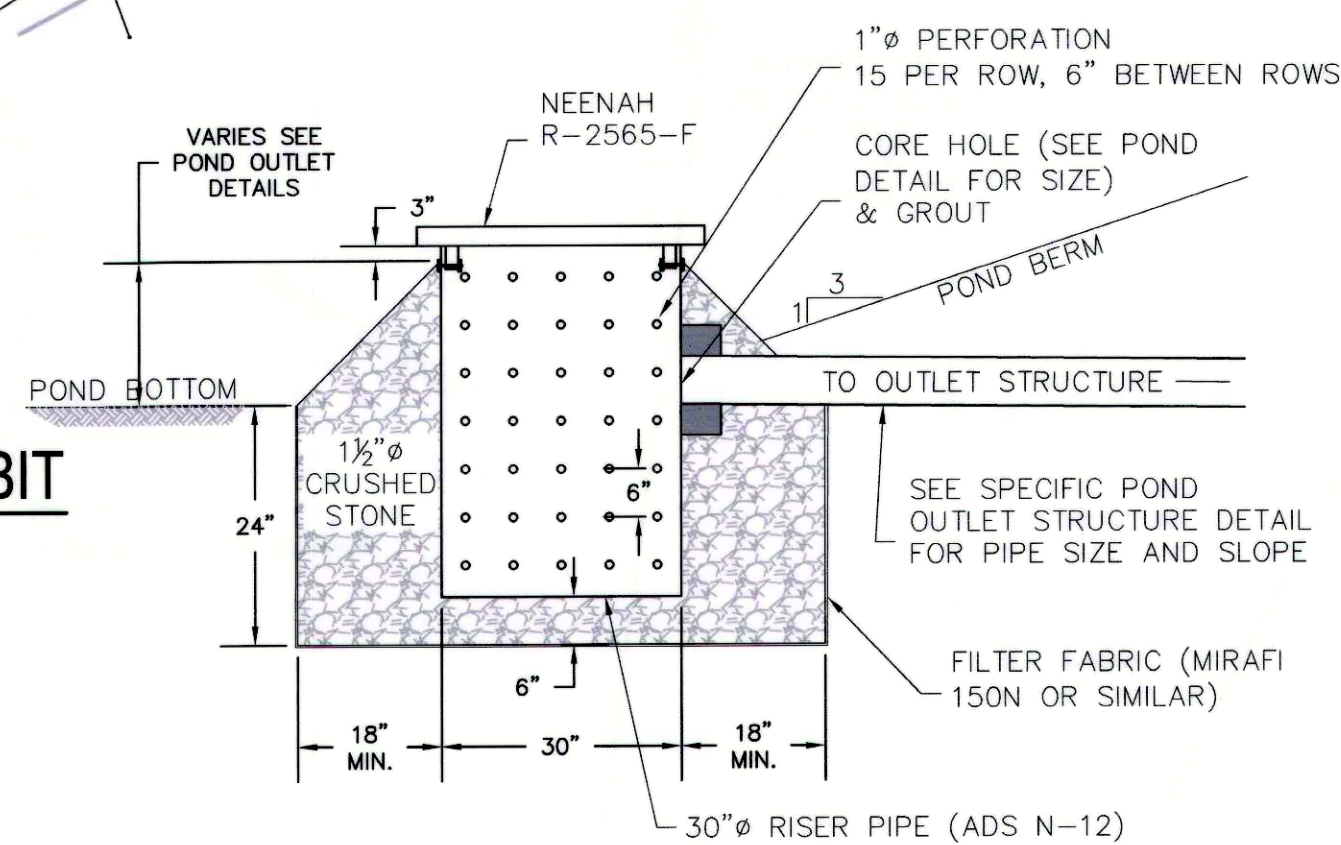

RISER DETAIL

SCALE: 1" = 2'

RESERVED FOR REGISTRY USE

GREGORY S. ROY
V.L.
N. 46070
REGISTERED
PROFESSIONAL ENGINEER

STANLEY R. DILLI
S. 3112
REGISTERED
PROFESSIONAL LAND SURVEYOR

I CERTIFY THIS PLAN CONFORMS TO THE RULES AND REGULATIONS OF THE REGISTERS OF DEEDS OF THE COMMONWEALTH OF MASSACHUSETTS

DATE APPROVED: _____

_____)
 _____)
 _____)
 _____)
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BEING A MAJORITY OF THE STOW PLANNING BOARD

DATE ENDORSED: _____

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STOW TOWN CLERK _____ DATE _____

APPROVAL REQUIRED UNDER THE SUBDIVISION CONTROL LAW

DATE APPROVED: _____

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STOW TOWN CLERK _____ DATE _____

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FRONTAGE = 50' SETBACKS: FRONT = 50'
 LOT AREA = 180,000 SQ. FT. SIDE = 45'
 OPEN SPACE (MIN.) = 10% REAR = 40'
 FLOOR AREA RATIO = NR LOT SHAPE (MIN.) = 0.25

CONVENTIONAL LOTS:

FRONTAGE = 200' SETBACKS: FRONT = 30'
 LOT AREA = 65,340 SQ. FT. SIDE = 25'
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OWNER: RICHARD F. RIEL **APPLICANT: ROBERT VISCO**
 113 WALCOTT STREET 30 OLD STOW ROAD
 STOW, MA 01775 HUDSON, MA 01749

BOOK/PAGE: MAP/PARCEL:
 BOOK 13501, PAGE 418 MAP R-1, PARCEL 31











JILLIAN'S LANE DEFINITIVE SUBDIVISION DEVELOPMENT STOW, MASSACHUSETTS DETAIL SHEET				
NO.	DATE	DESCRIPTION	BY	
2	7/7/16	REVISED PER PLANNING BOARD COMMENTS	P.J.W.	
3	8/24/16	REVISED PER PLANNING BOARD DECISION	P.J.W.	
4	9/27/16	REVISED DRIVEWAY LOCATION	P.J.W.	
5	12/6/16	REVISED PER PLANNING BOARD COMMENTS	P.J.W.	
6	1/12/17	REVISED PER PLANNING BOARD DECISION	P.J.W.	

PREPARED BY:

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GSR	GSR	GSR	8
DATE:	JOB NUMBER:	DRAWING NO.	OF 11
3/18/16	5139	5139-DET	



RESERVED FOR REGISTRY USE

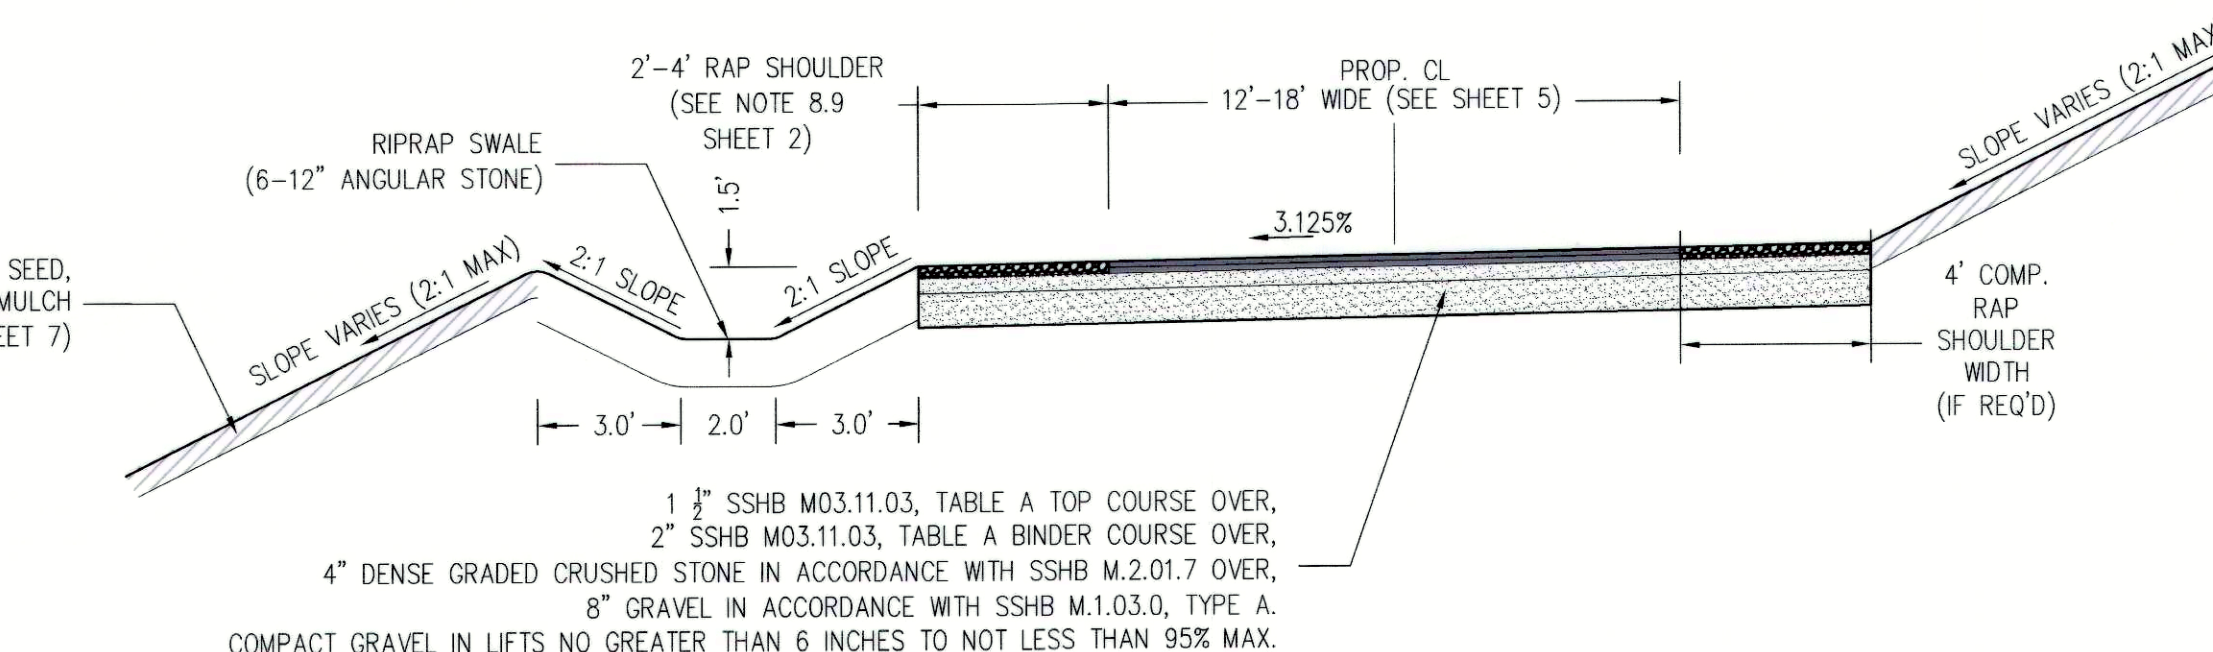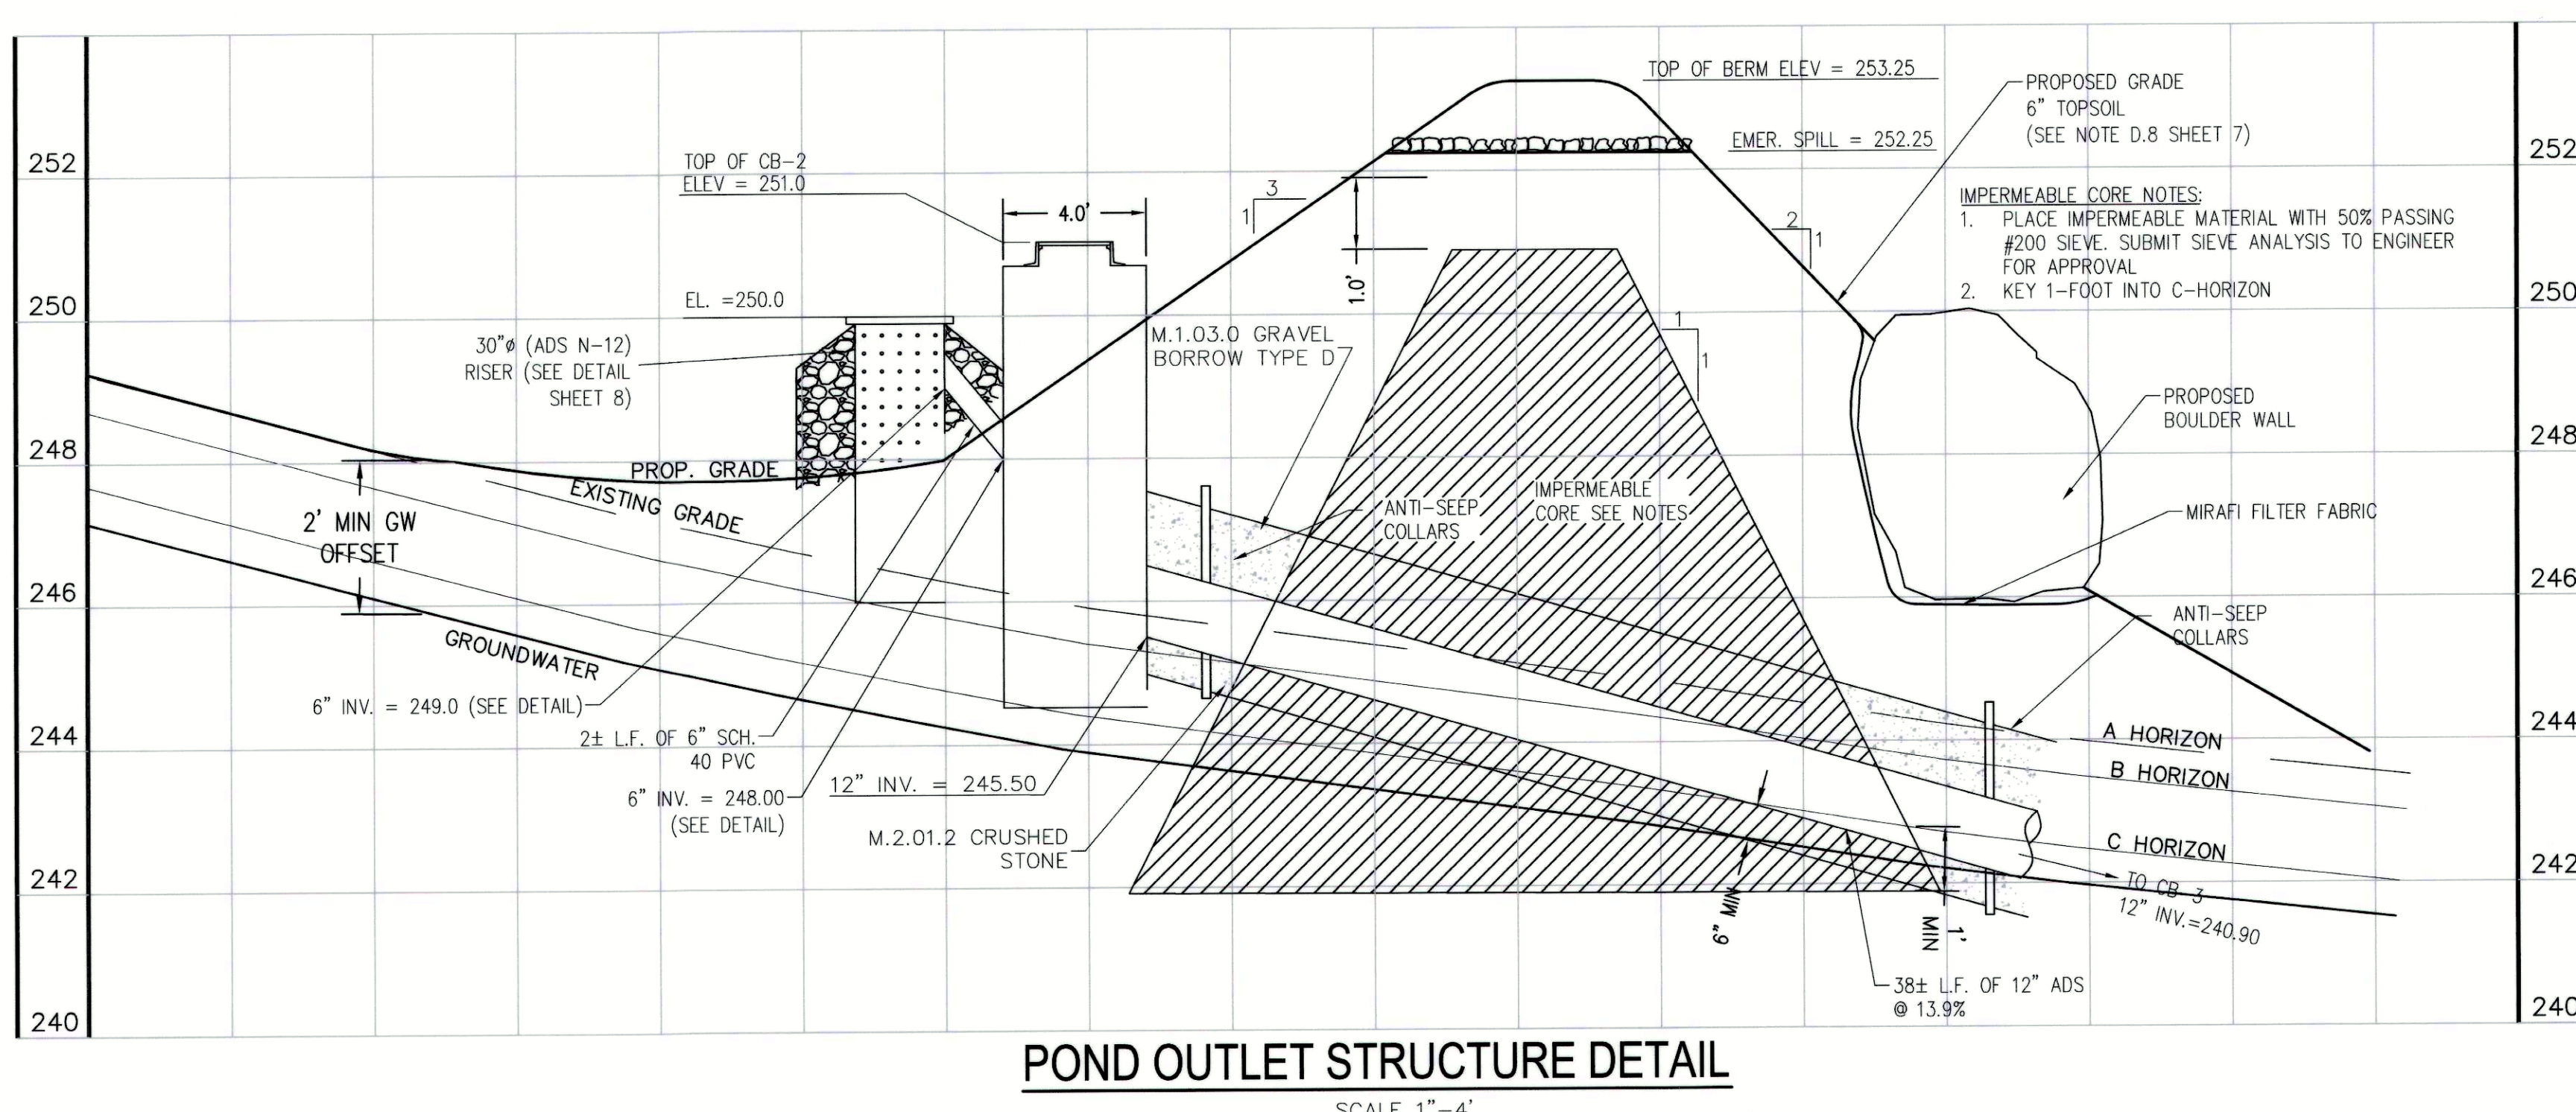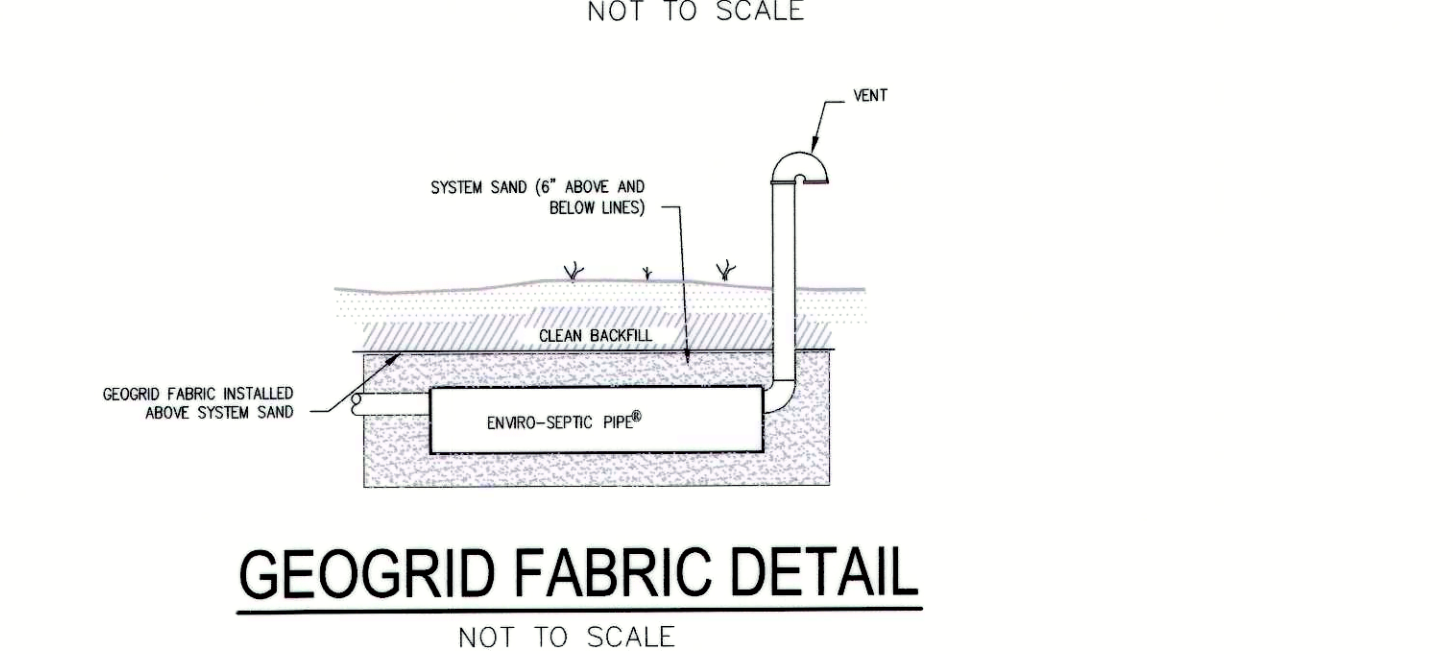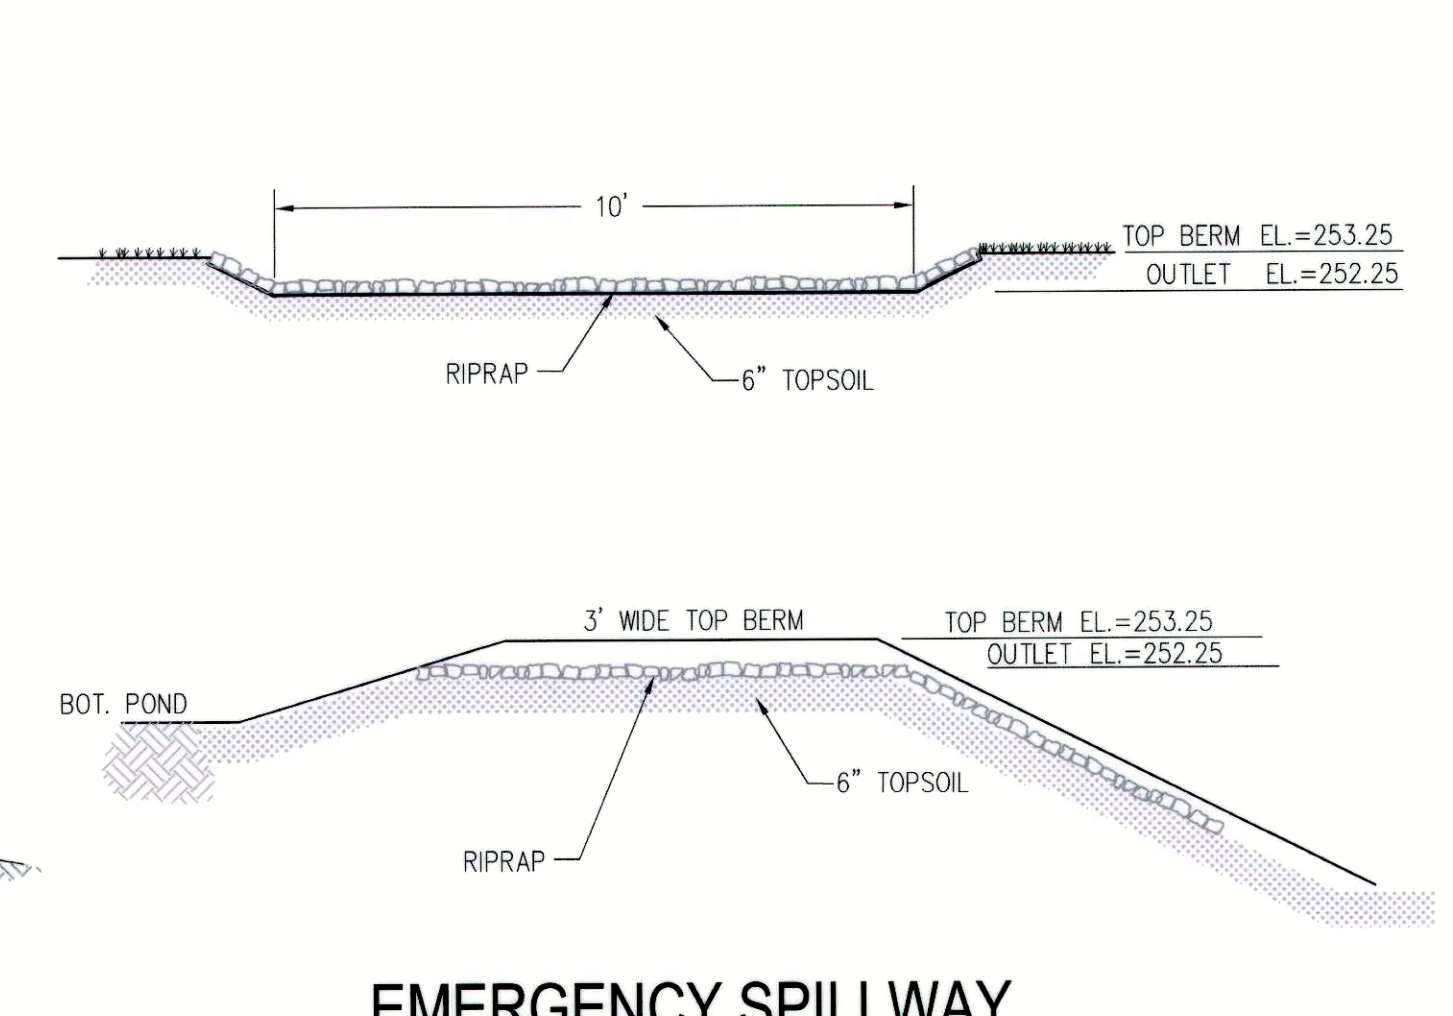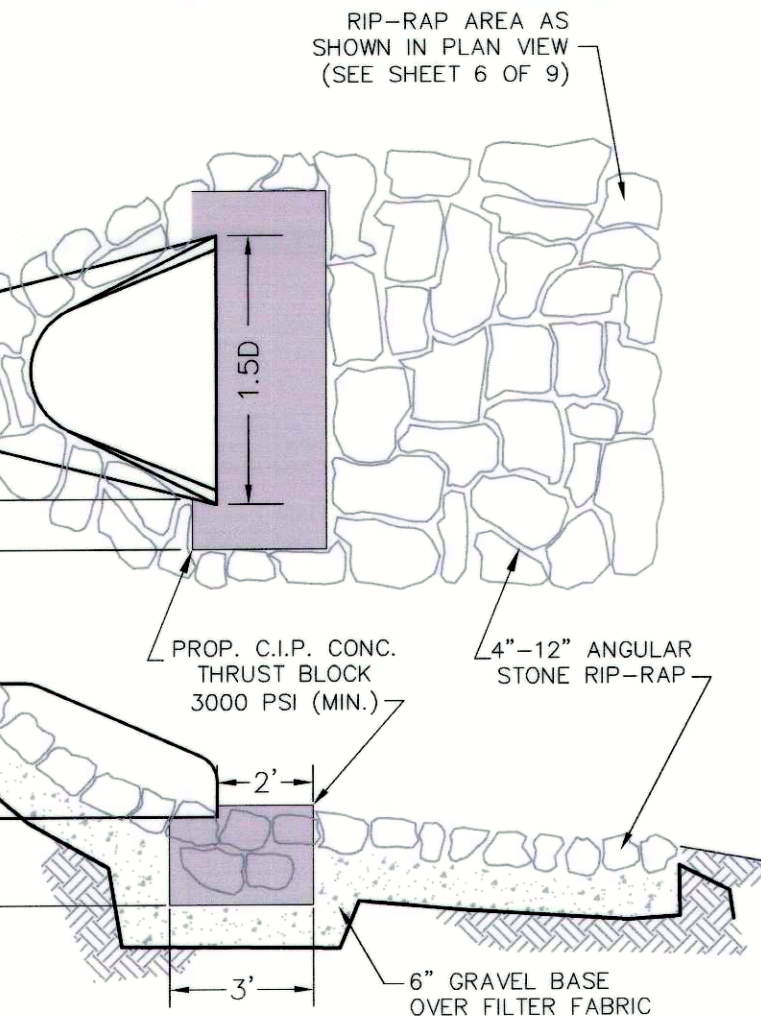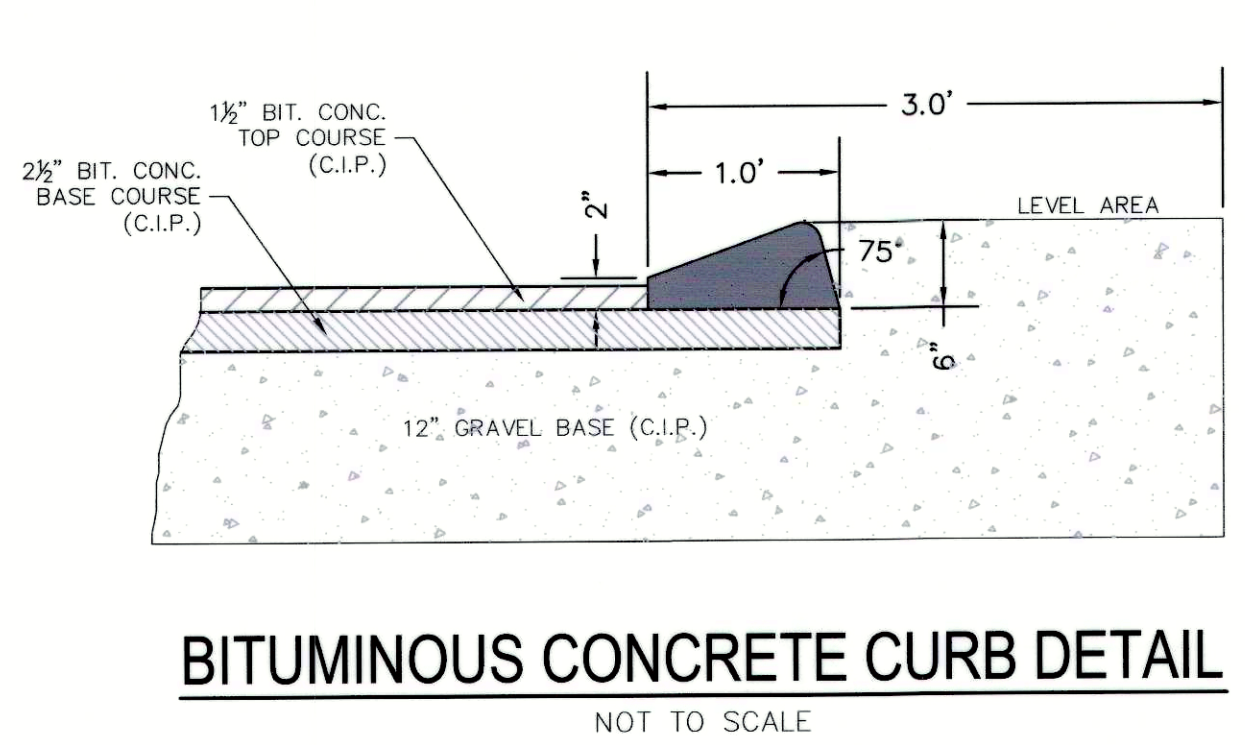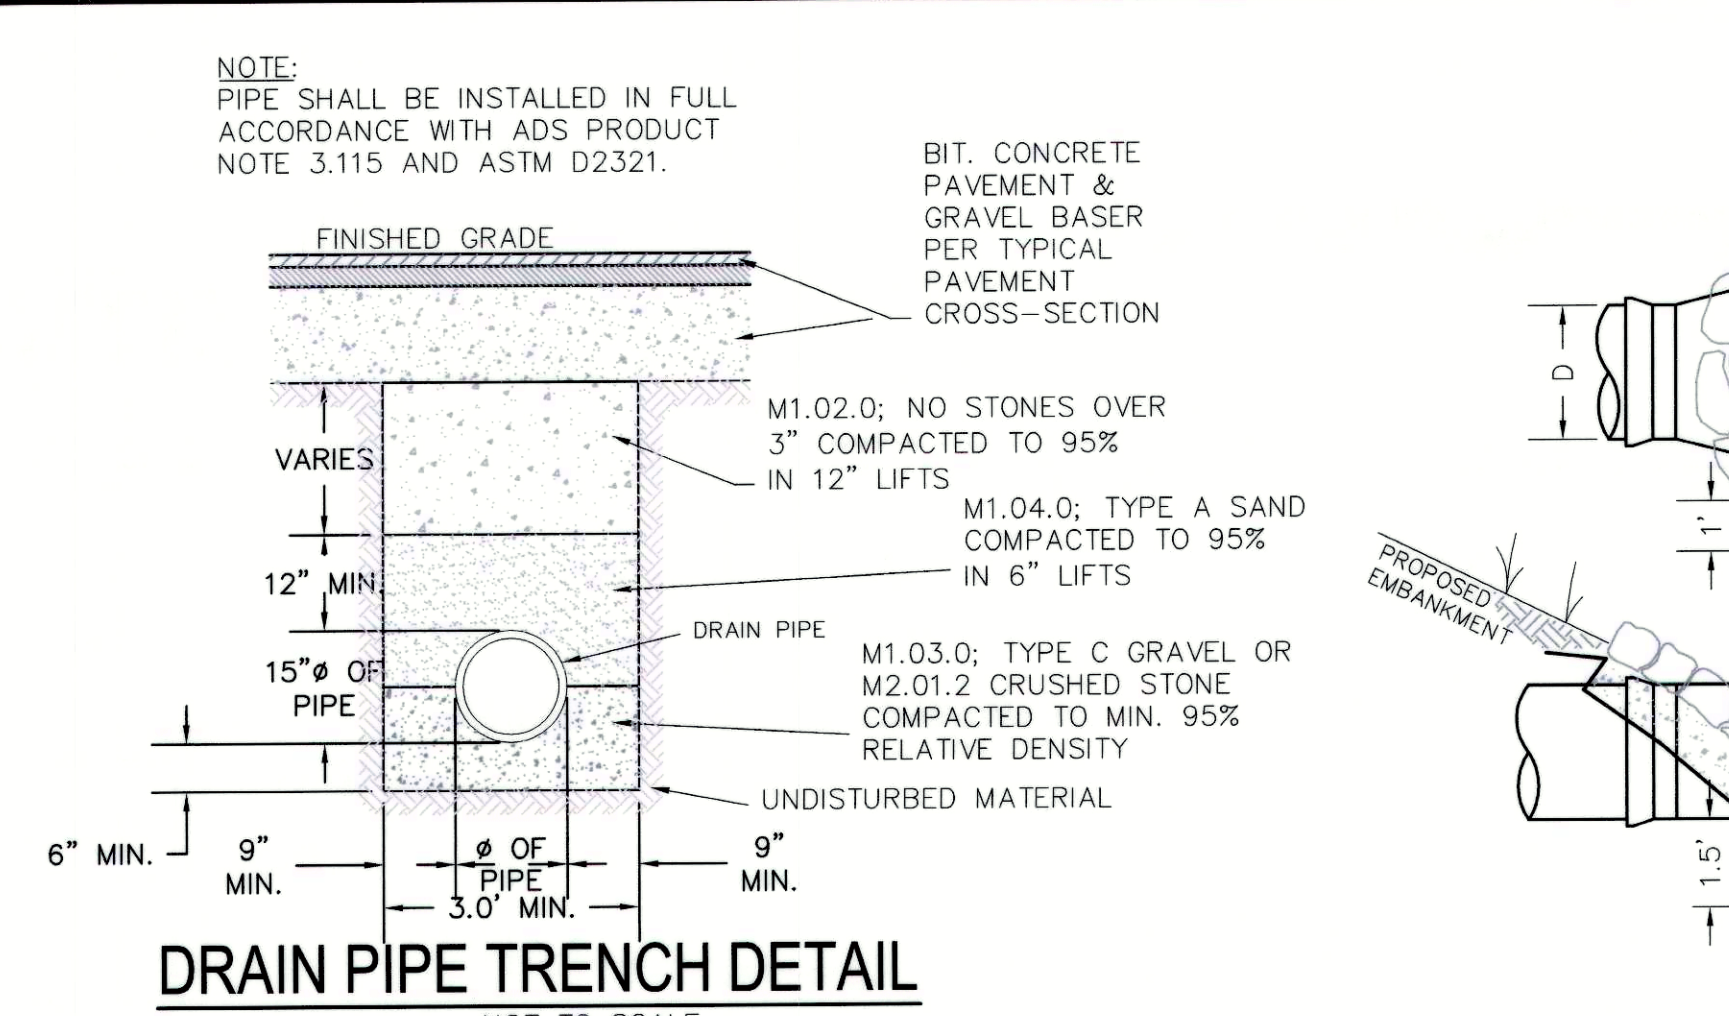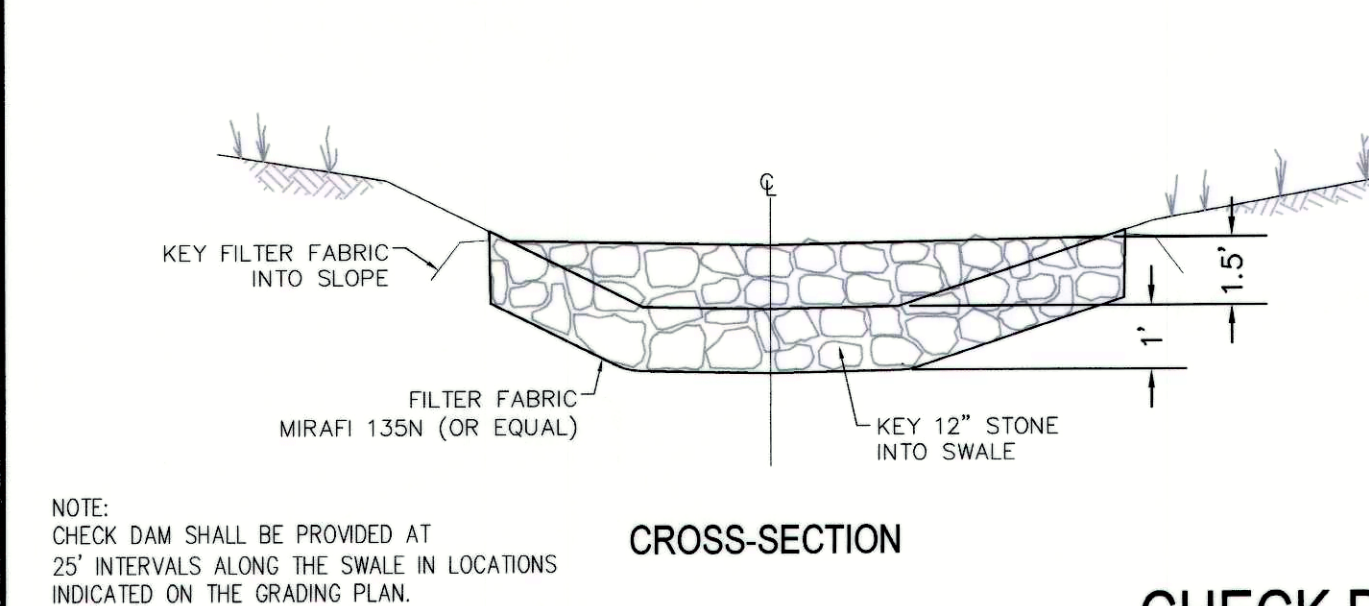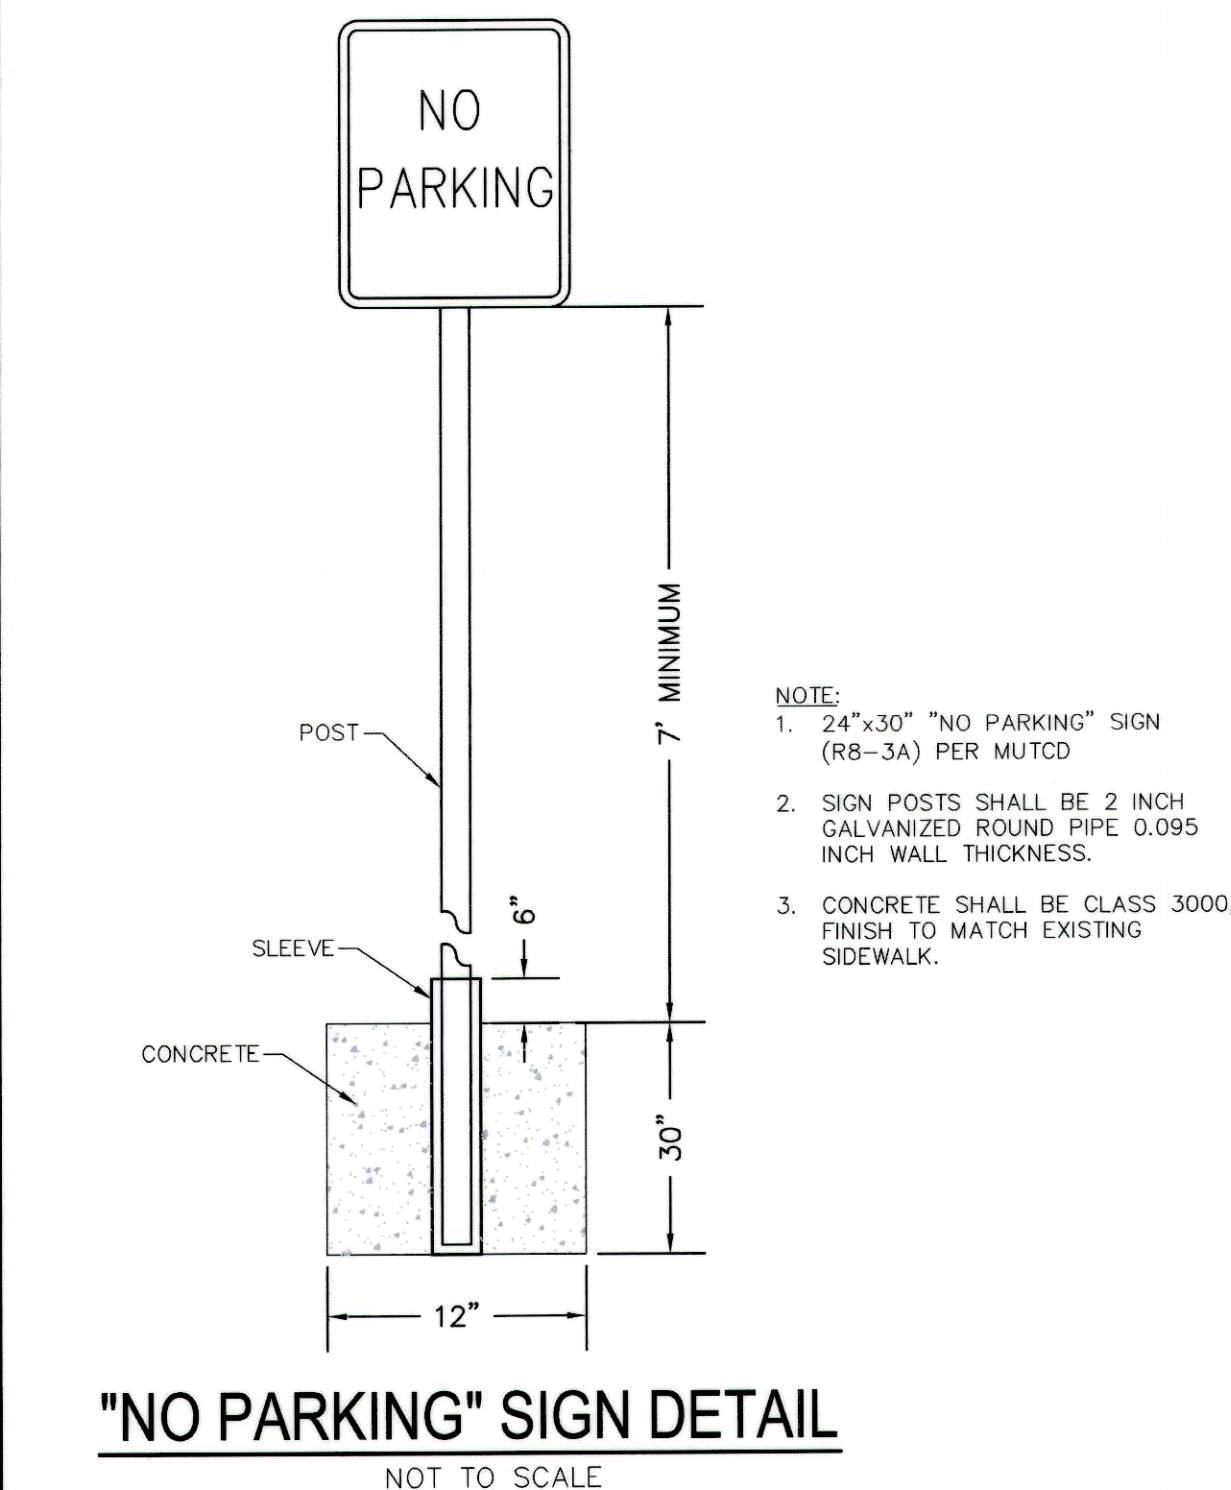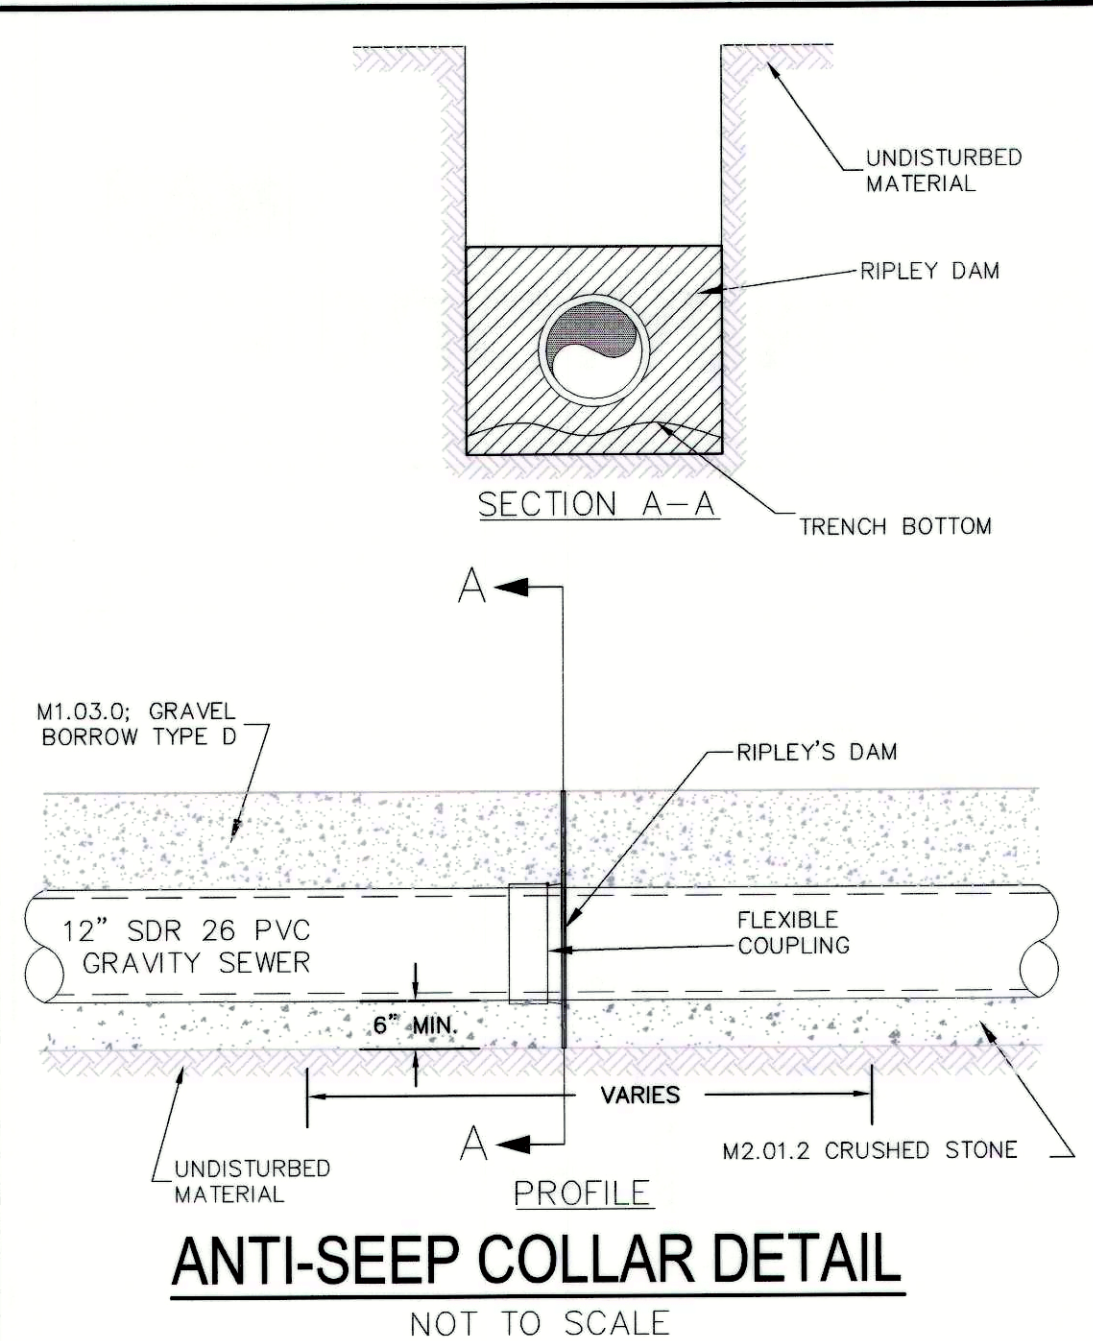PROFESSIONAL ENGINEER

PROFESSIONAL LAND SURVEYOR

APPROVAL REQUIRED UNDER THE SUBDIVISION CONTROL LAW
DATE APPROVED: _____

BEING A MAJORITY OF THE STOW PLANNING BOARD

DATE ENDORSED: _____

APPROVED SUBJECT TO CONDITIONS SET FORTH
IN A COVENANT EXECUTED BY _____ AND TO BE RECORDED HEREWITH
DATED _____

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HEREBY CERTIFY THAT THE NOTICE OF THE APPROVAL OF THIS PLAN BY THE
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STOW TOWN CLERK _____ DATE _____

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LOT AREA = 180,000 SQ. FT.
OPEN SPACE (MIN.) = 10%
FLOOR AREA RATIO = NR

CONVENTIONAL LOTS:
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LOT AREA = 65,340 SQ. FT.
OPEN SPACE (MIN.) = 10%
FLOOR AREA RATIO = NR

SETBACKS:
FRONT = 50'
SIDE = 45'
REAR = 40'

LOT SHAPE (MIN.):
FRONT = 0.25
SIDE = 0.40
REAR = 0.40

OWNER: RICHARD F. RIEL
113 WALCOTT STREET
STOW, MA 01775

APPLICANT: ROBERT VISCO
30 OLD STOW ROAD
HUDSON, MA 01749

BOOK/PAGE:
BOOK 13501, PAGE 418

MAP/PARCEL:
MAP R-1, PARCEL 31

JILLIAN'S LANE
DEFINITIVE SUBDIVISION DEVELOPMENT
STOW, MASSACHUSETTS
DETAIL SHEET

NO.	DATE	DESCRIPTION	BY
2	7/7/16	REVISED PER PLANNING BOARD COMMENTS	PJW
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6	1/12/17	REVISED PER PLANNING BOARD DECISION	PJW


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BOLTON, MASSACHUSETTS 01740


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GSR	GSR	GSR	9


DATE: 3/18/16 JOB NUMBER: 5139 DRAWING NO. 5139-DET OF 11




CB-1 VORTSENTRY WATER TREATMENT UNIT
NOT TO SCALE

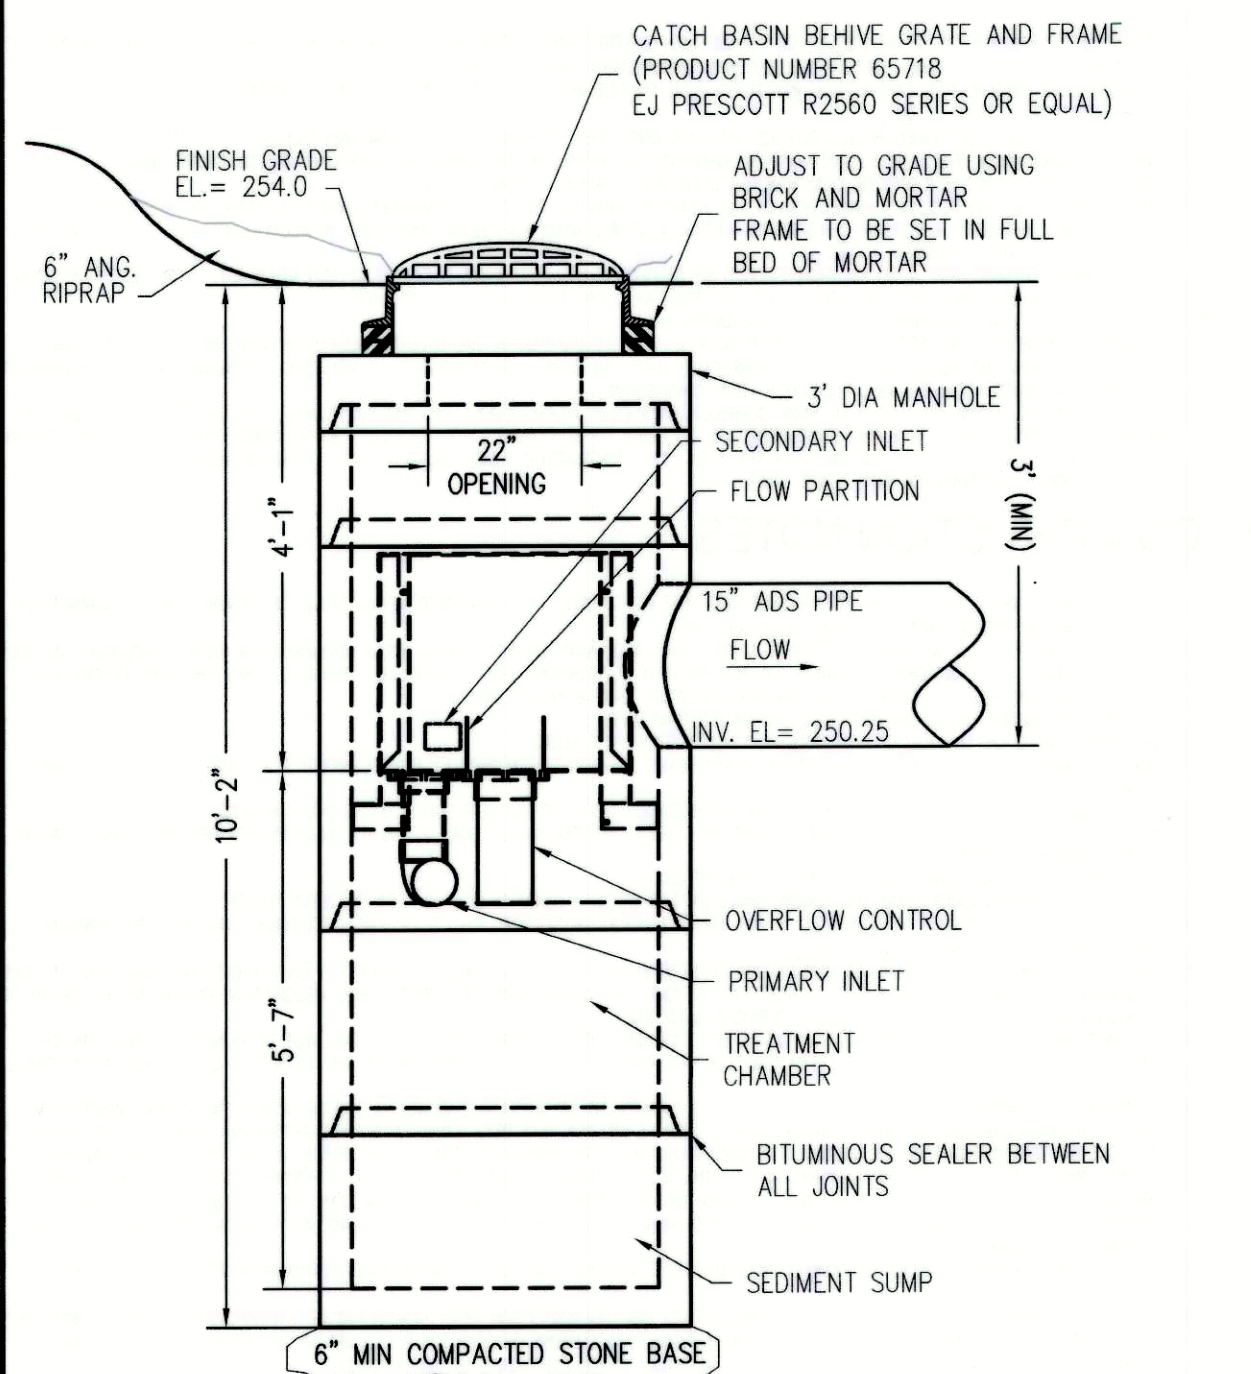

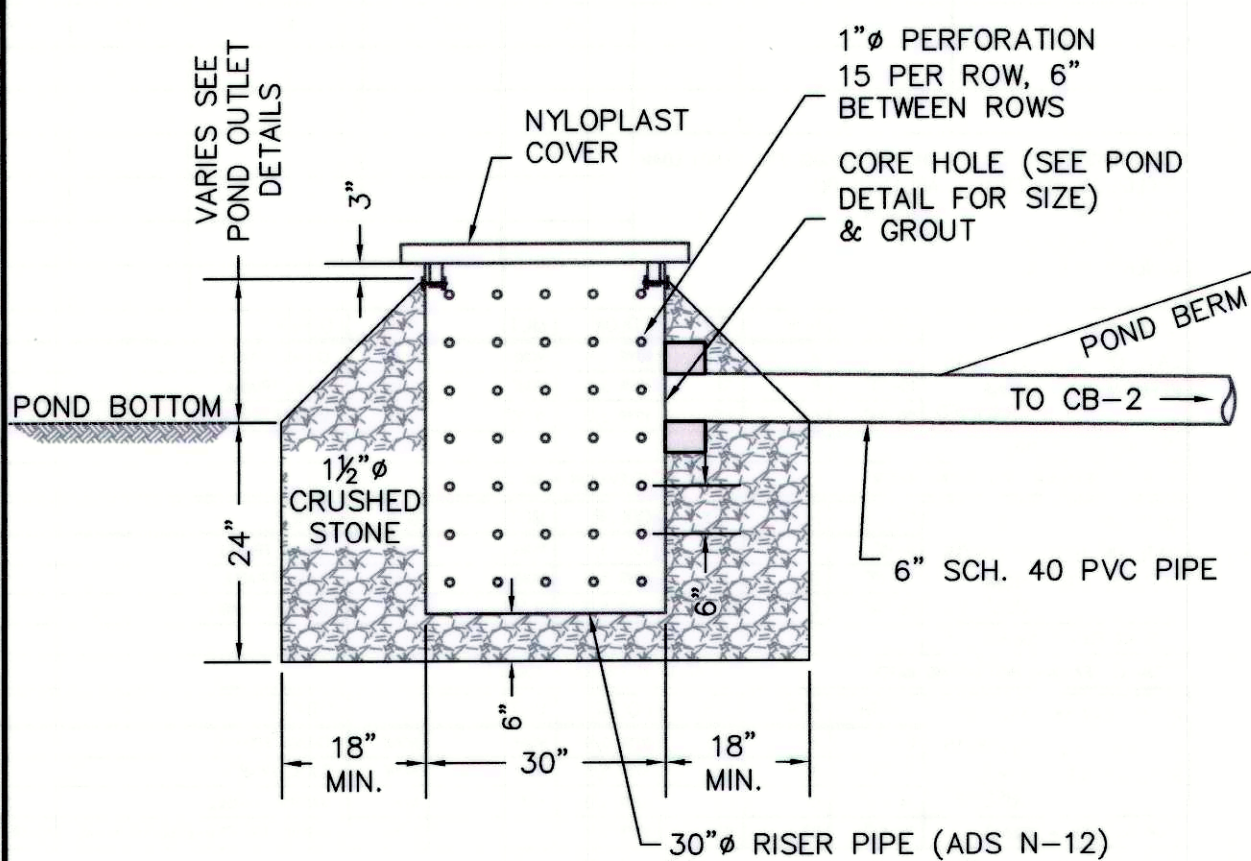
RISER DETAIL
SCALE: 1"=2'

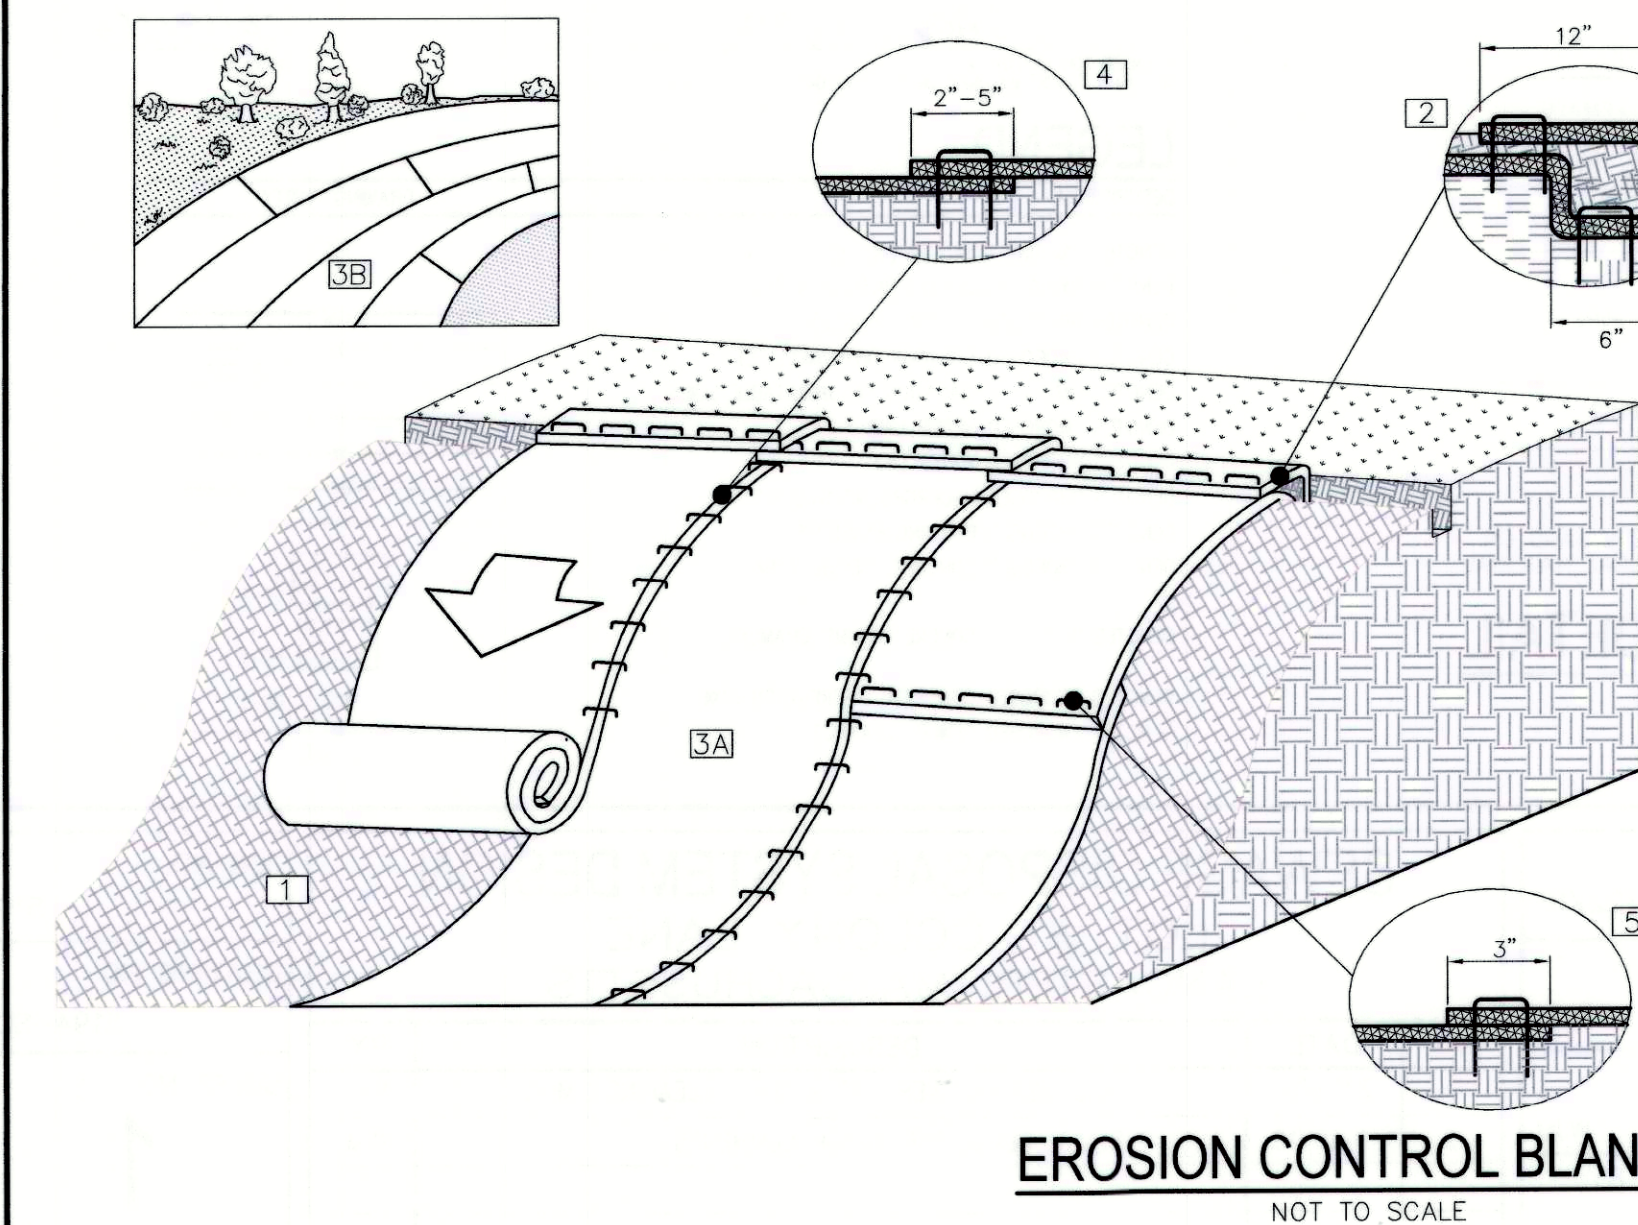

EROSION CONTROL BLANKET
NOT TO SCALE

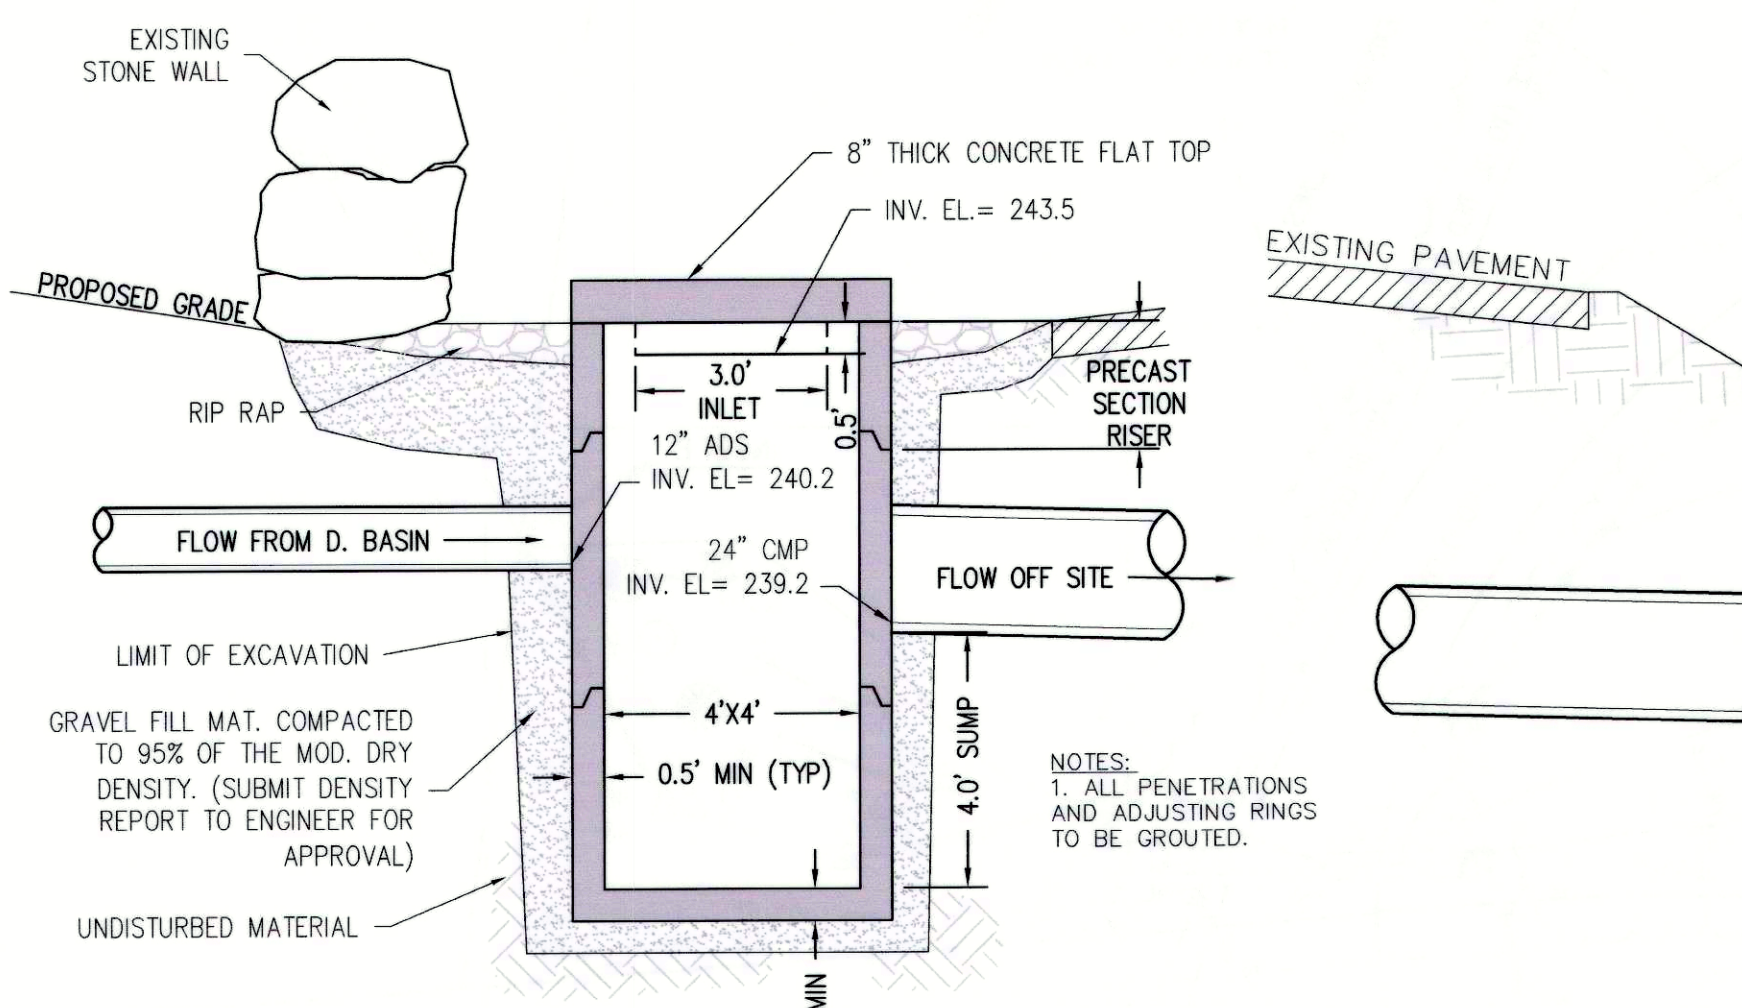


CB-3 DROP INLET WITH COVER AND CULVERT
NOT TO SCALE

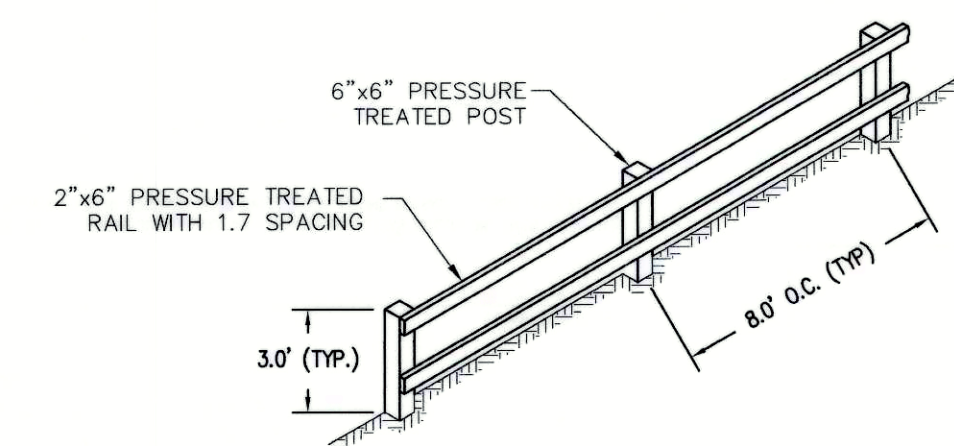


WOODEN GUARDRAIL DETAIL
NOT TO SCALE


- NOTES:**
1. EROSION CONTROL BLANKETS SHALL BE INSTALLED ON ALL SLOPES 3:1 OR GREATER.
 2. PREPARE SOIL AND HYDROSEED (WITH MULCH & TACKIFIER) BEFORE INSTALLING ROLLED EROSION CONTROL PRODUCTS (RECPs).
 3. BEGIN AT THE TOP OF THE SLOPE BY ANCHORING THE RECPs IN A 6" DEEP X 6" WIDE TRENCH WITH APPROXIMATELY 12" OF RECPs EXTENDED BEYOND THE UP-SLOPE PORTION OF THE TRENCH. ANCHOR THE RECPs WITH A ROW OF STAPLES/STAKES APPROXIMATELY 12" APART IN THE BOTTOM OF THE TRENCH. BACKFILL AND COMPACT THE TRENCH AFTER STAPLING. APPLY ADDITIONAL SEED TO THE COMPACTED SOIL, AND FOLD THE REMAINING 12" PORTION OF RECPs BACK OVER THE SEED AND COMPACTED SOIL. SECURE RECPs OVER COMPACTED SOIL WITH A ROW OF STAPLES/STAKES SPACED APPROXIMATELY 12" APART ACROSS THE WIDTH OF THE RECPs.
 4. ROLL THE RECPs (A) DOWN OR (B) HORIZONTALLY ACROSS THE SLOPE. RECPs WILL UNROLL WITH APPROPRIATE SIDE AGAINST THE SOIL SURFACE. ALL RECPs MUST BE SECURELY FASTENED TO SOIL SURFACE BY PLACING STAPLES/STAKES IN APPROPRIATE LOCATIONS AS SHOWN IN THE STAPLE PATTERN GUIDE.
 5. THE EDGES OF PARALLEL RECPs MUST BE STAPLED WITH APPROXIMATELY 2"-5" OVERLAP DEPENDING ON THE RECPs TYPE.
 6. CONSECUTIVE RECPs SPICED DOWN THE SLOPE MUST BE END OVER END (SHINGLE STYLE) WITH AN APPROXIMATE 3" OVERLAP. STAPLE THROUGH OVERLAPPED AREA, APPROXIMATELY 12" APART ACROSS ENTIRE RECPs WIDTH.
- *NOTE:**
IN LOOSE SOIL CONDITIONS, THE USE OF STAPLE OR STAKE LENGTHS GREATER THAN 6" MAY BE NECESSARY TO PROPERLY SECURE THE RECP'S.

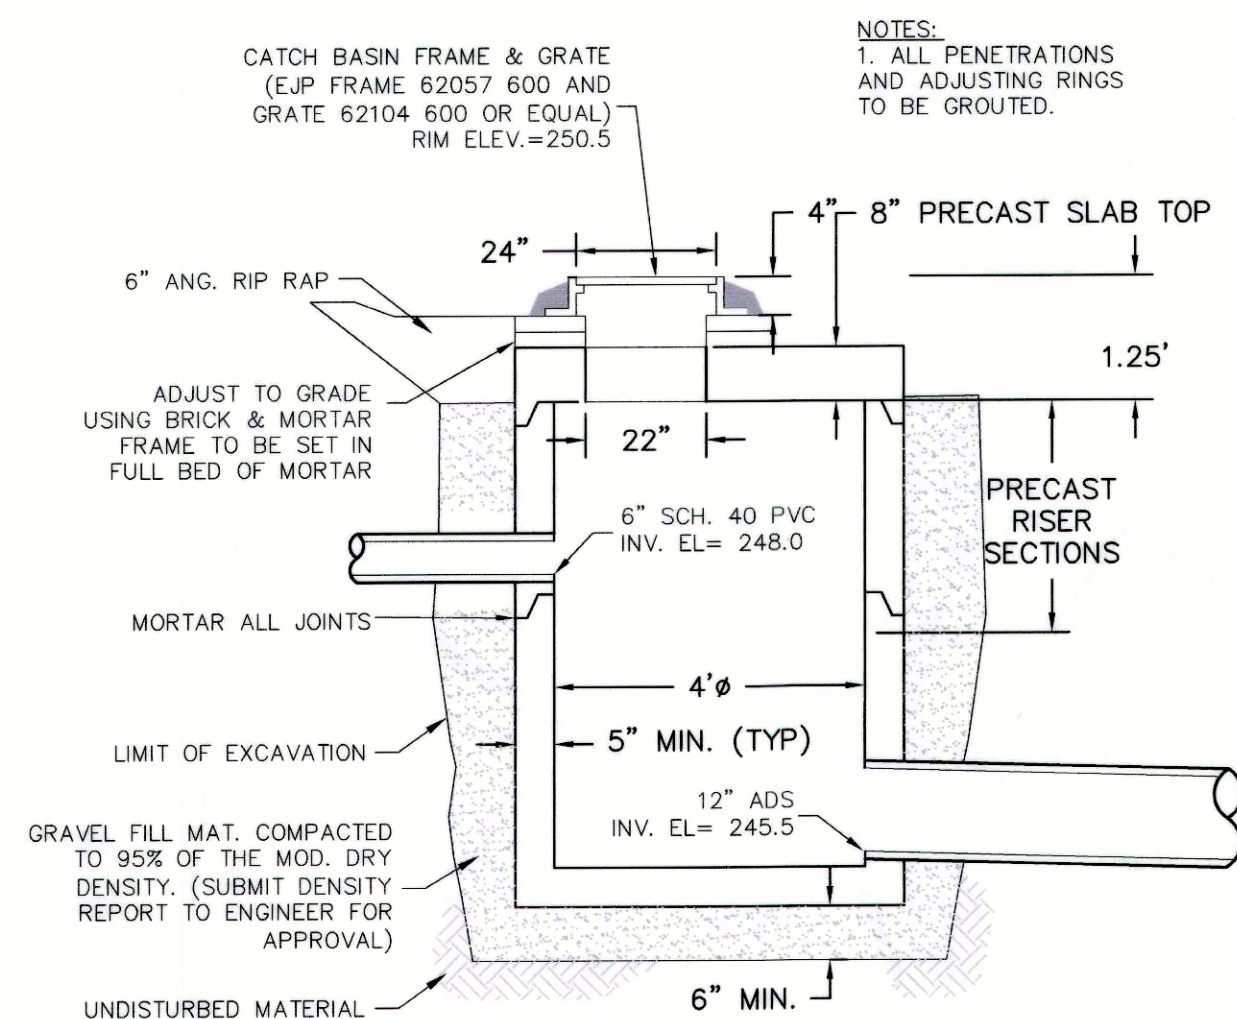


CB-2 FIELD BASIN GRATE AND CULVERT
NOT TO SCALE

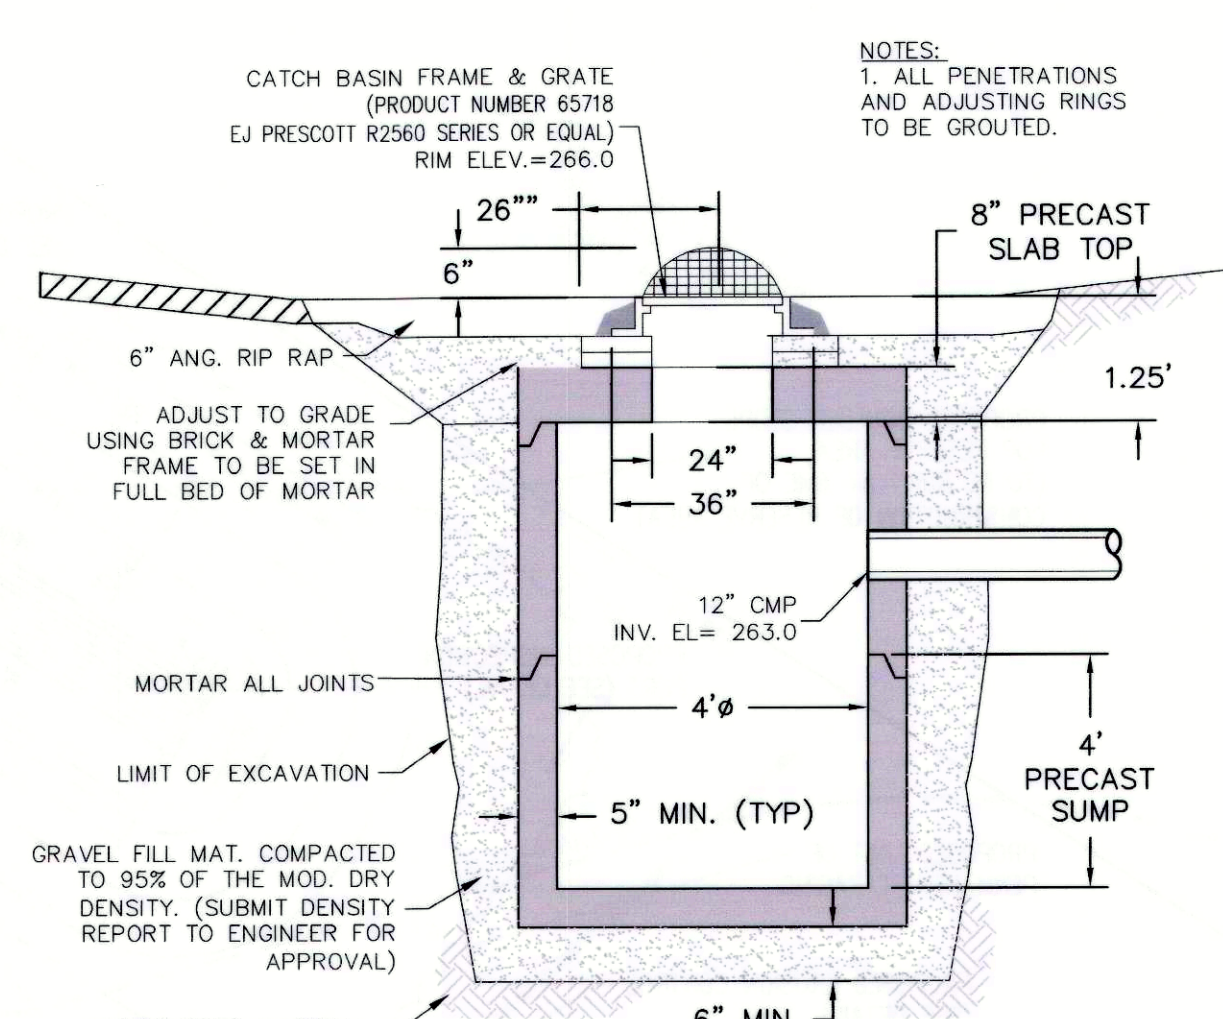


CB-4 FIELD BASIN W/ BEEHIVE GRATE
NOT TO SCALE

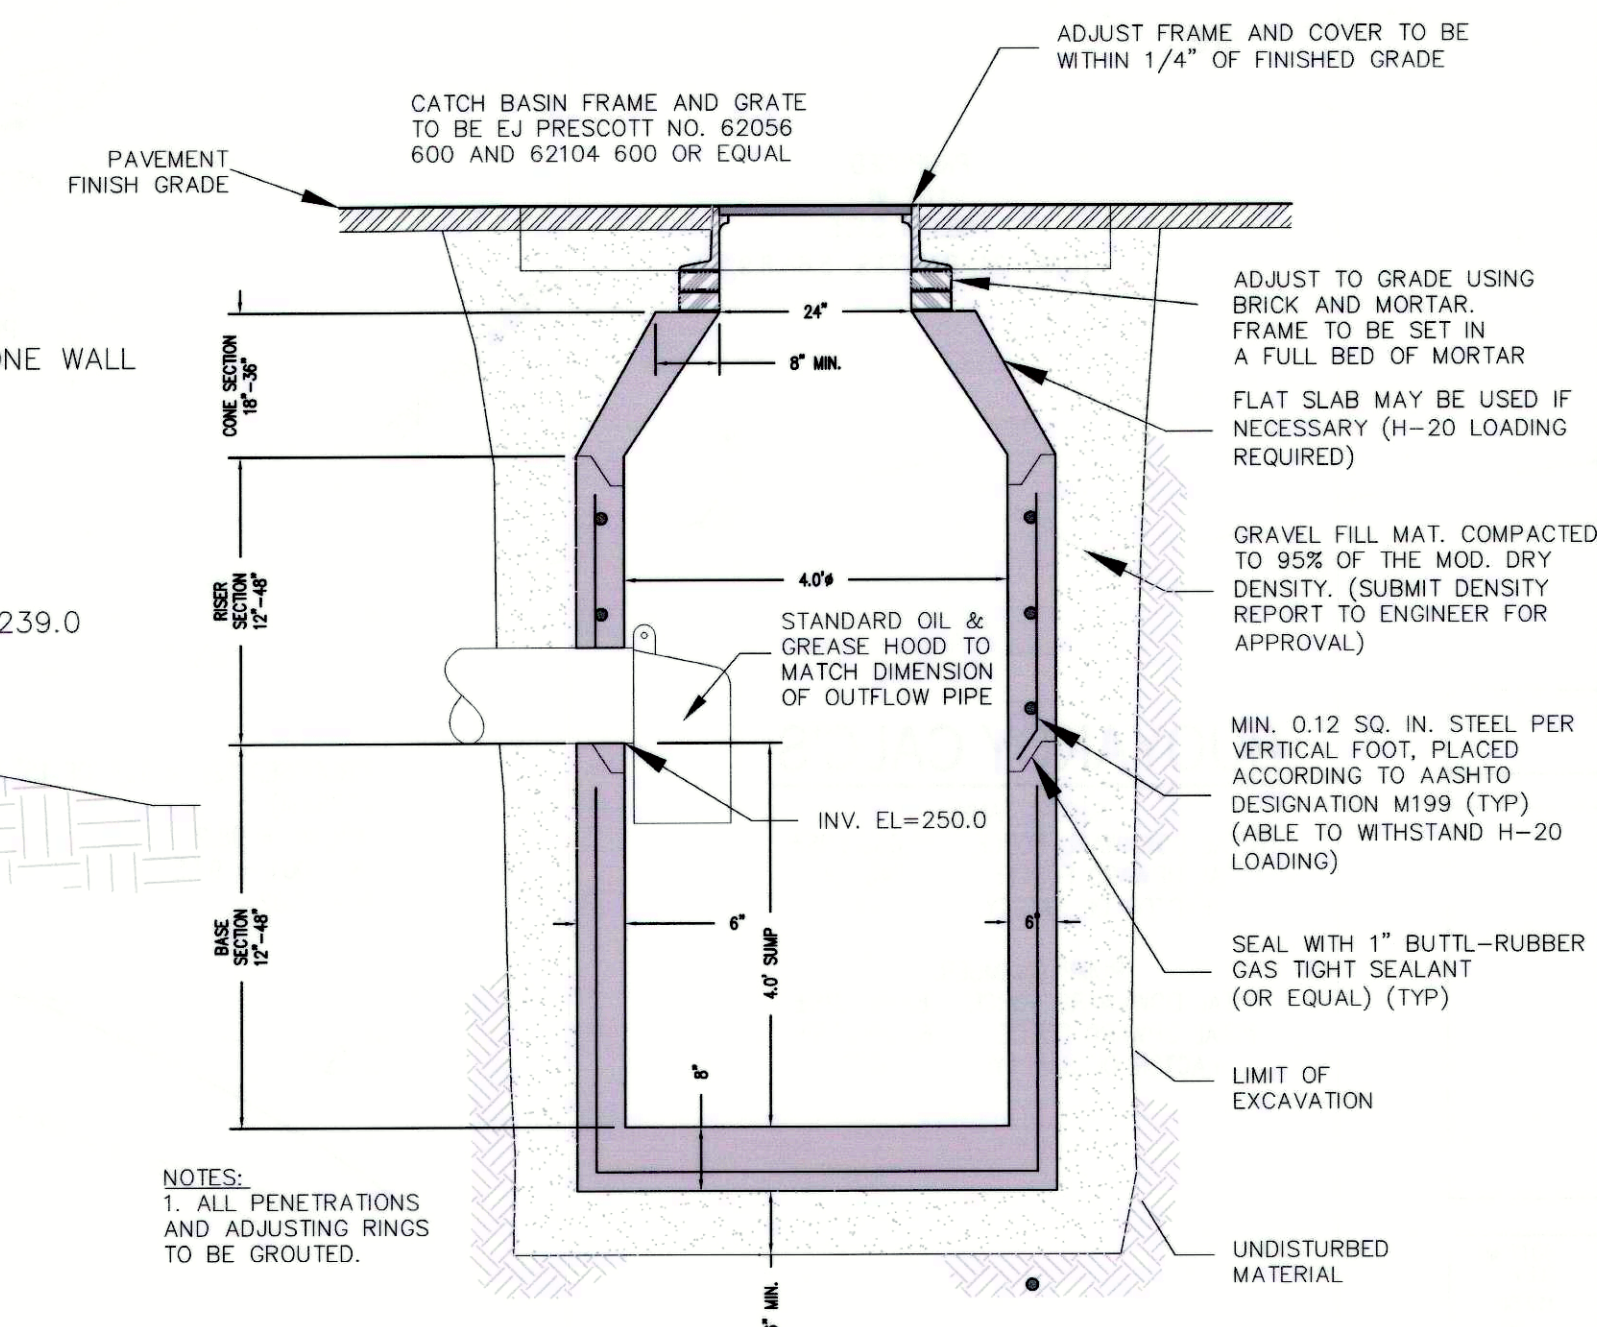

CB-5 DEEP SUMP CONCRETE CATCH BASIN
NOT TO SCALE

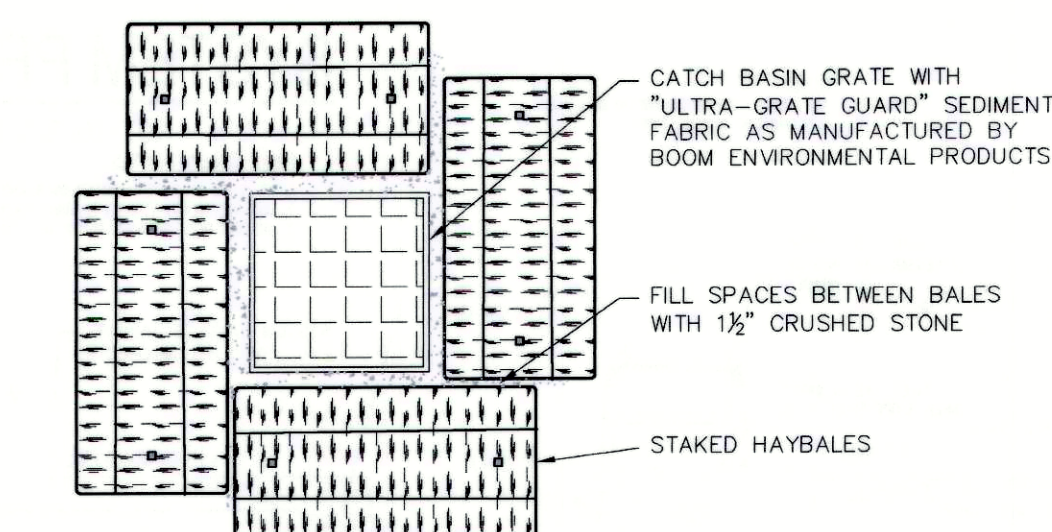

CATCH BASIN SEDIMENT TRAP
NOT TO SCALE

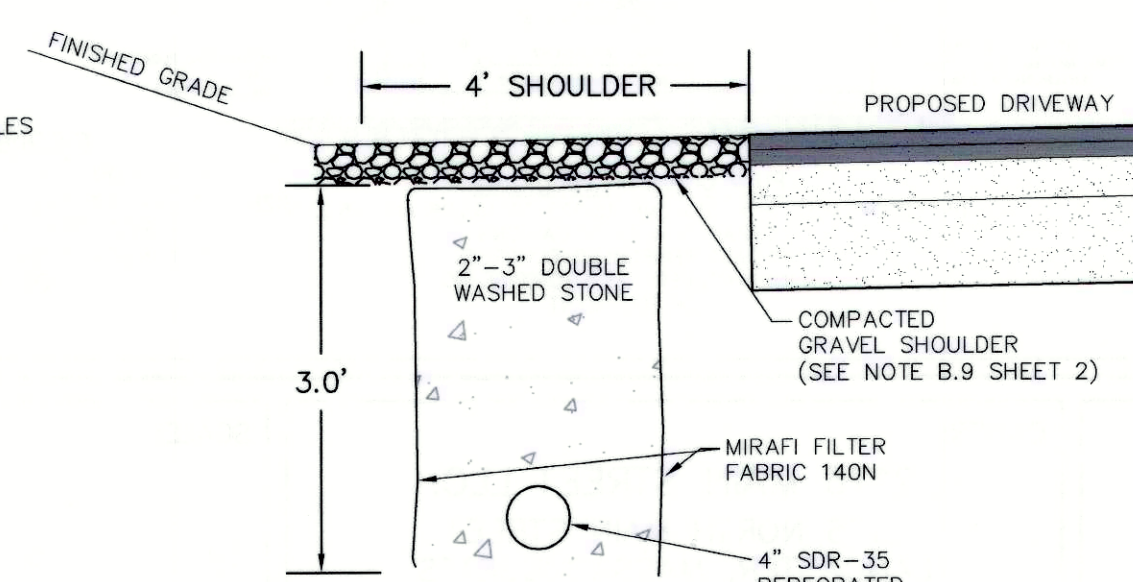

INTERCEPTOR DRAIN

RESERVED FOR REGISTRY USE

PROFESSIONAL ENGINEER
GREGORY S. ROY
NO. 33182
1/2/17

PROFESSIONAL LAND SURVEYOR
STANLEY R. DILLIS
NO. 33182
1/2/17

I CERTIFY THIS PLAN CONFORMS TO THE RULES AND REGULATIONS OF THE REGISTERS OF DEEDS OF THE COMMONWEALTH OF MASSACHUSETTS

APPROVAL REQUIRED UNDER THE SUBDIVISION CONTROL LAW
DATE APPROVED: _____

BEING A MAJORITY OF THE STOW PLANNING BOARD

DATE ENDORSED: _____

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OWNER: RICHARD F. RIEL 113 WALCOTT STREET STOW, MA 01775	APPLICANT: ROBERT VISCO 30 OLD STOW ROAD HUDSON, MA 01749
BOOK/PAGE: BOOK 13501, PAGE 418	MAP/PARCEL: MAP R-1, PARCEL 31

JILLIAN'S LANE
DEFINITIVE SUBDIVISION DEVELOPMENT
STOW, MASSACHUSETTS
DETAIL SHEET

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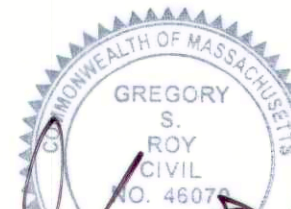
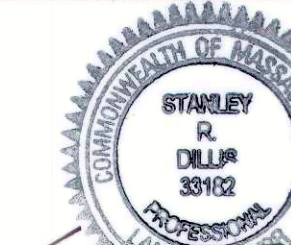
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www.DucharmeandDillis.com

DESIGN BY: GSR	DRAWN BY: GSR	CHECKED BY: GSR	SHEET NO. 10
DATE: 3/18/16	JOB NUMBER: 5139	DRAWING NO. 5139-DET	OF 11

 <p><i>Greg S. Roy</i> 1/12/17</p> <p>PROFESSIONAL ENGINEER</p>	<p>RESERVED FOR REGISTRY USE</p>
 <p><i>Stanley R. Diller</i> 1/12/17</p> <p>PROFESSIONAL LAND SURVEYOR</p> <p>I CERTIFY THIS PLAN CONFORMS TO THE RULES AND REGULATIONS OF THE REGISTERS OF DEEDS OF THE COMMONWEALTH OF MASSACHUSETTS</p>	